Lakehead University - Chancellor Paterson Library 5th Floor - Teachers Common Renovations

955 Oliver Rd, Thunder Bay, ON

Project #2017024



FORM ARCHITECTURE ENGINEERING

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MECHANICAL ENGINEER:

MCW CONSULTANTS LTD.

Suite 615 - 207 Queen Quay W Toronto, Ontario, M5J TA/ www.mcw.com


Tel: (416) 598-2920


ELECTRICAL ENGINEER:

AG ENGINEERING


2nd Floor - 1111 Victoria Ave E Thunder Bay, Ontario, P7C 1B7 www.agpeng.com

Tel: (807) 622-3456 Fax: (807) 622-3633

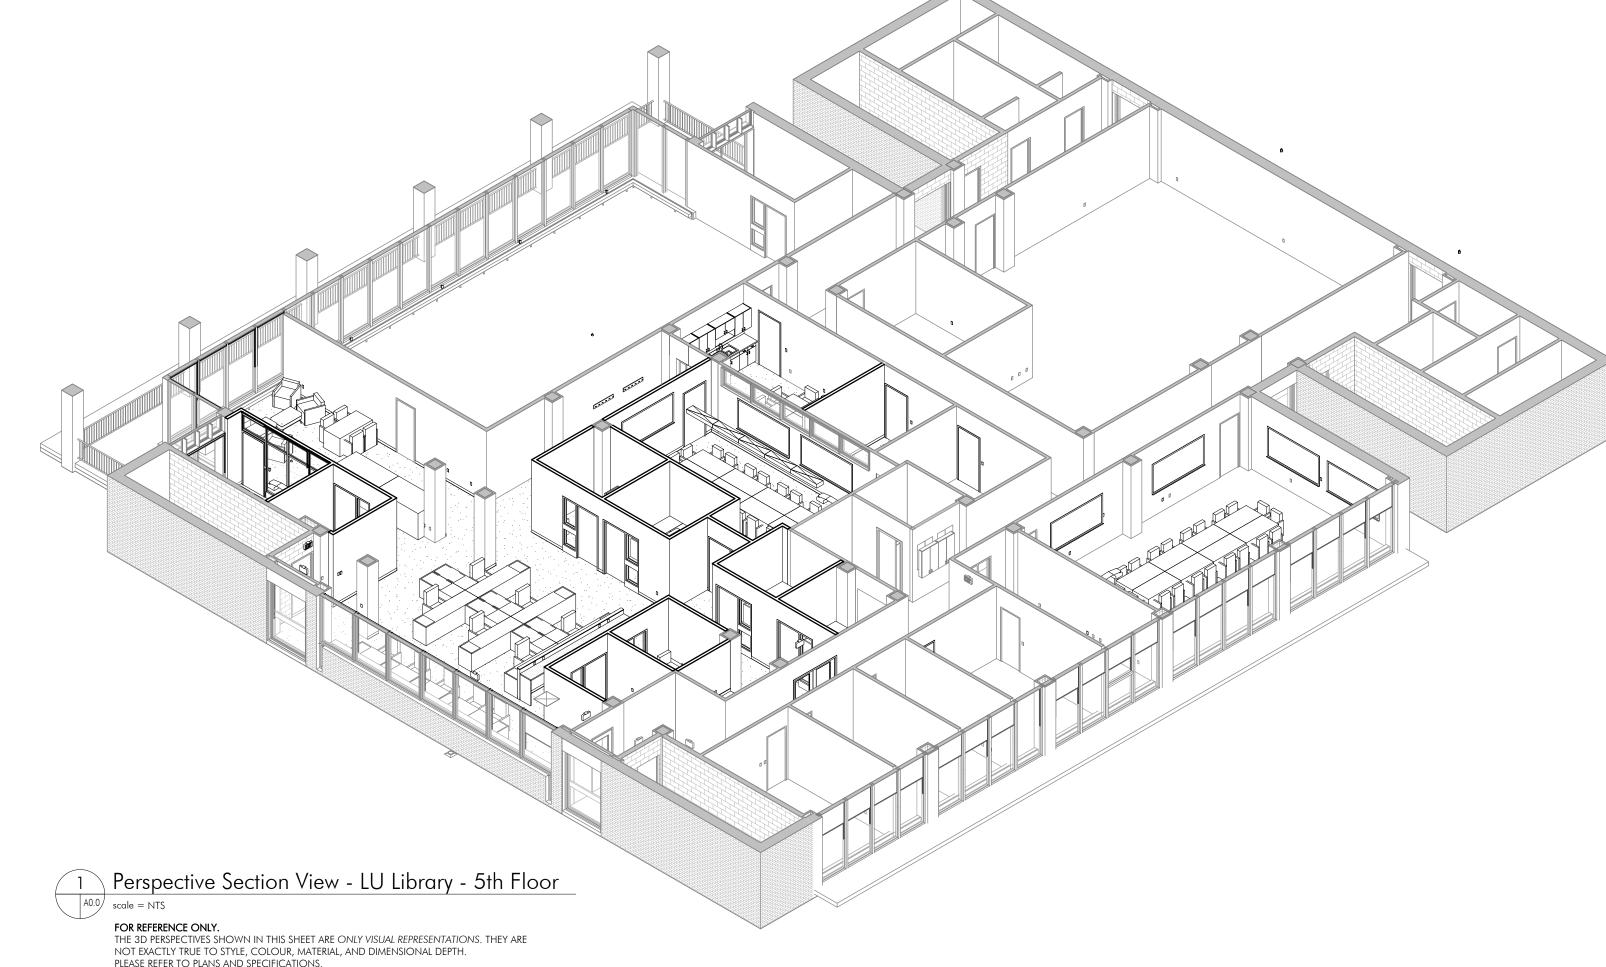

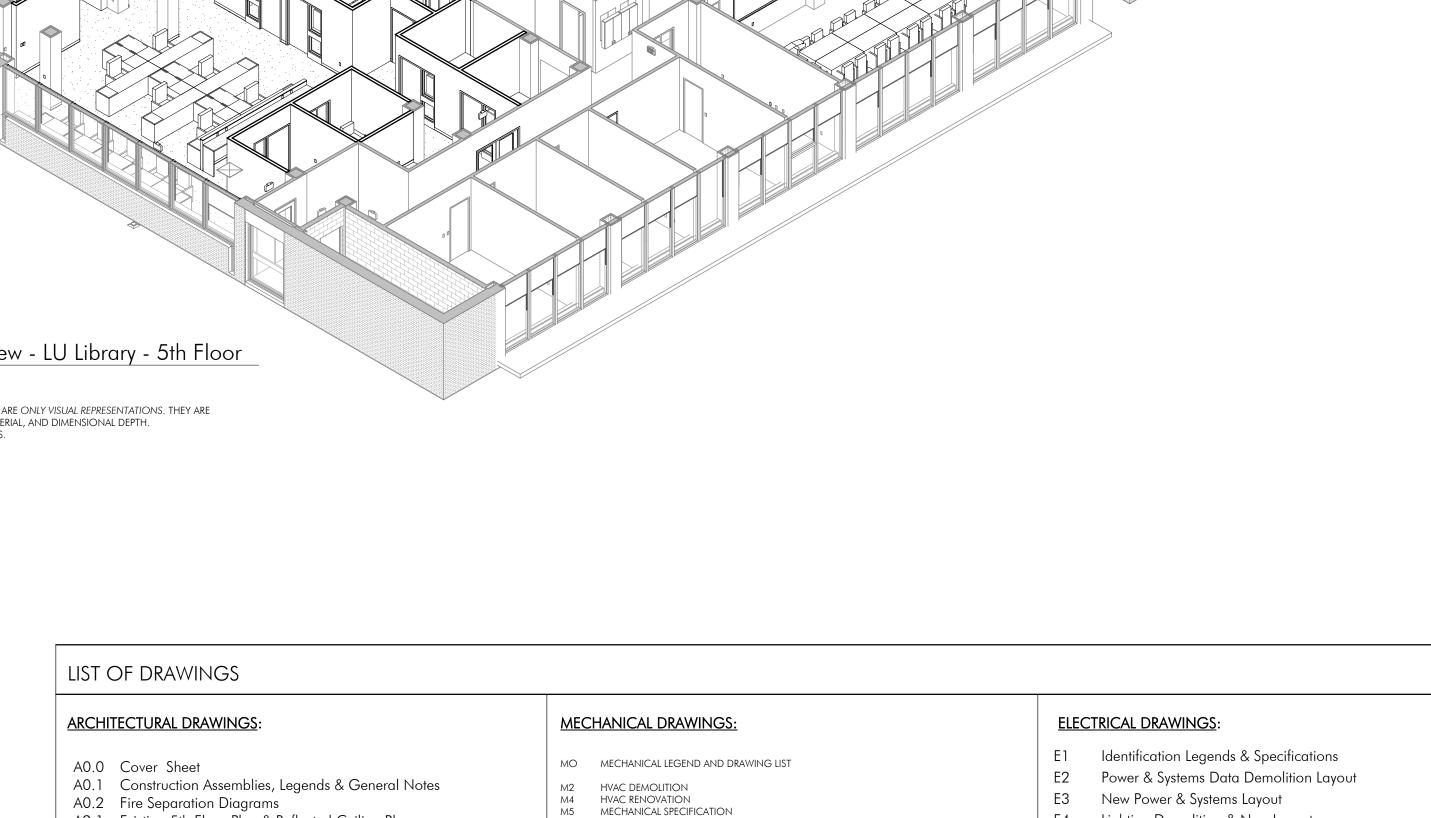



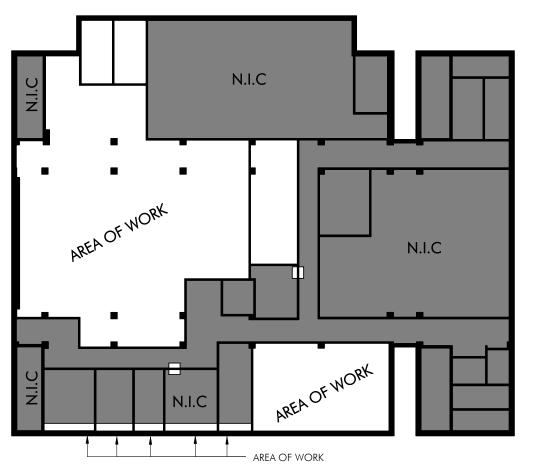

KEY PLAN - N.T.S

""4""	2017.09.06	Issued for Tender with revision						
"3"	2017.08.22	Issued for Tender						
"2"	2017.08.09	Revision as per Meeting #5						
"]"	2017.07.27	Revision as per Owner Review						
"0"	2017.07.17	Issued for 100% Review						
REVISION	DATE	DESCRIPTION						
ASSOCIATION ASSOCIATION OF ARCHITECTS Z KIMBERLEY J. MCKEE								
· Concession	7178	Internet						

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BETTER PLACES FOR PEOPLE

PROJECT NAME:

CBRE - LU Chancellor Paterson Library

Teachers Common Renovations

955 Oliver Rd

Thunder Bay, ON


SHEET TITLE:

Cover Sheet

August 2017 PROJECT: 2017024

- A2.1 Existing 5th Floor Plan & Reflected Ceiling Plan A2.2 Demolition Floor Plan, Demolition Reflected Ceiling Plan
- A2.3 Renovation Floor Plan, Renovation Reflected Ceiling Plan
- A2.4 Renovation Building Sections
- A3.1 Wall Sections, Plan and Section Details
- A4 SERIES NOT USED
- A5.1 Interior Elevations
- A6.1 Millwork Details
- A7.1 Finishes Plan, Furniture Layout & Schedule
- M1 PLUMBING DEMOLITION M3 PLUMBING RENOVATION

E4 Lighting Demolition & New Layouts

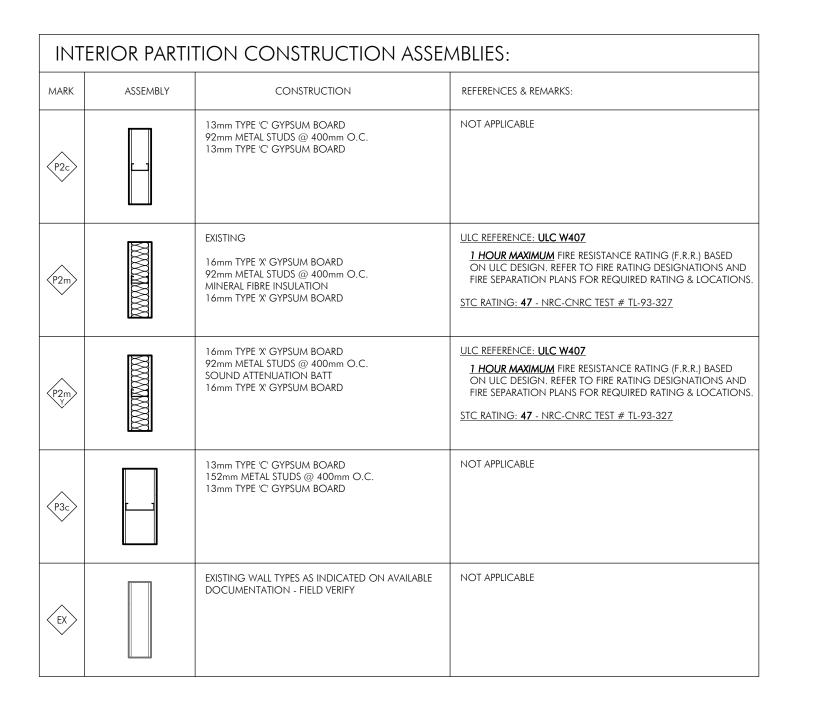

EXTERIOR WALL CONSTRUCTION ASSEMBLIES:									
MARK	ASSEMBLY	CONSTRUCTION	REFERENCES & REMARKS:						
₩1>		EXISTING EXTERIOR WALL 13 GYPSUM METAL STUD CMU BLOCK INSULATION AIRSPACE BRICK	WALL NOT TO BE REMOVED. MAKE GOOD DURING DEMOLITION AND RENOVATION STAGES.						
W2		EXISTING EXTERIOR WALL CMU BLOCK INSULATION AIRSPACE BRICK	WALL NOT TO BE REMOVED. MAKE GOOD DURING DEMOLITION AND RENOVATION STAGES.						

FLOOR CONSTRUCTION ASSEMBLIES:								
MARK	ASSEMBLY	CONSTRUCTION	REFERENCES & REMARKS:					
₩1>	A	EXISTING FLOOR EXISTING CARPET FLOORING AND ITS SUBSTRATE VAPOUR BARRIER 180mm CONCRETE FLOORING	EXISTING FLOORING TO RE REPLACE WITH NEW FLOORING - REFER TO ROOM FINISH SCHEDULE					

						Doc	or And Frame S	ichedule - New	Construction					
Ooor						Door				F	rame			
No.	Room Name	Set	Width	Height	Туре	Mat'l	Finish	Glazing	Туре	Mat'l	Finish	Glazing	Fire Rating	Comments
03	WORKSPACE	1	965	2150	D2	НМ	PTD	LAM	F2	HM	PTD	-	-	
03A	OFFICE	2	965	2150	D1	SCW	CLEAR	-	F5	HM	PTD	LAM	-	
03B	OFFICE	2	965	2150	D1	SCW	CLEAR	-	F5	HM	PTD	LAM	-	
03C	EXIST. IT RM	3	965	2150	D1	НМ	PTD	-	F1	HM	PTD	-	-	
03D	CONFERENCE	4	965	2150	D1	SCW	CLEAR	-	F5	HM	PTD	LAM	-	
03Da	CONFERENCE	4	965	2150	D1	SCW	CLEAR	-	F1	HM	PTD	-	-	
03E	OFFICE	2	965	2150	D1	SCW	CLEAR	-	F5	HM	PTD	LAM	-	
03F	OFFICE	2	965	2150	D1	SCW	CLEAR	-	F5	HM	PTD	LAM	-	
03J	OFFICE	2	965	2150	D1	SCW	CLEAR	-	F5	HM	PTD	LAM	-	
03K	OFFICE	2	965	2150	D1	SCW	CLEAR	-	F5	HM	PTD	LAM	-	
03K	COLLABORATION	4	950	2150	D1	SCW	CLEAR	-	\$1	HM	PTD	LAM	-	
03L	OFFICE	2	965	2150	D1	SCW	CLEAR	-	F5	HM	PTD	LAM	-	
05	EXIST. LOUNGE	5	965	2150	D1	НМ	PTD	-	F1	HM	PTD	-	-	
05a	GREEN ROOM	3	965	2150	D1	НМ	PTD	-	F1	HM	PTD	-	-	
06	EXIST. OFFICE	2	965	2150	D1	НМ	PTD	-	F1	HM	PTD	-	-	
)3a	WORKSPACE	0	800	2150	EXIST. D1	EXIST. HM	NEW PTD	-	EXIST. F1	EXIST. HM	NEW PTD	-	-	New paint renovation tenant side only.
004	EXIST. STAIRS	0	914	2150	EXIST. D3	EXIST. HM	NEW PTD	-	EXIST. F1	EXIST. HM	NEW PTD	-	-	New paint renovation tenant side only.


NOTE:

ROOF AND FLOOR CONSTRUCTION ASSEMBLY NOT

AFFECTED BY DEMOLITION AND RENOVATION.

FLOORING ONLY TO BE CHANGED. REFER TO

SPECIFICATIONS AND ROOM FINISH SCHEDULE.

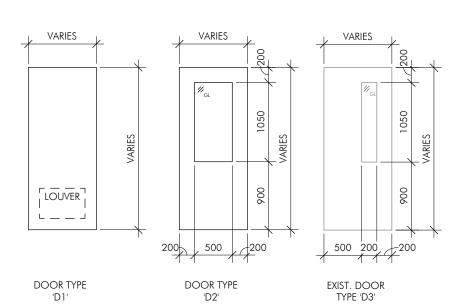



Door Type Legend

scale = 1 : 50

1. REFER TO DOOR AND FRAME SCHEDULE FOR DOOR DIMENSIONS.


- 2. REFER TO SPECIFICATIONS FOR APPROVED MANUFACTURERS. DIMENSIONS MAY VARY TO SUIT FRAME MATERIAL AND PROFILES AVAILABLE.
- 3. REFER TO DOOR AND FRAME SCHEDULE FOR TYPE OF GLAZING OR INSERTS. 4. REFER TO MECHANICAL DRAWINGS FOR LOCATIONS OF DOOR LOUVERS.
- 5. REFER TO PLANS AND INTERIOR ELEVATIONS FOR SWING OR OPERATION OF DOOR.

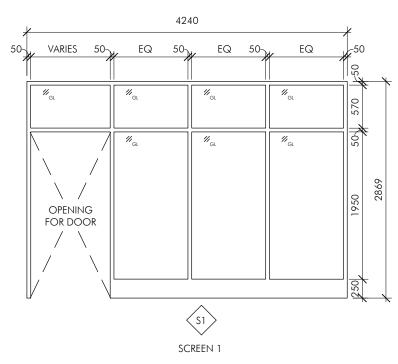

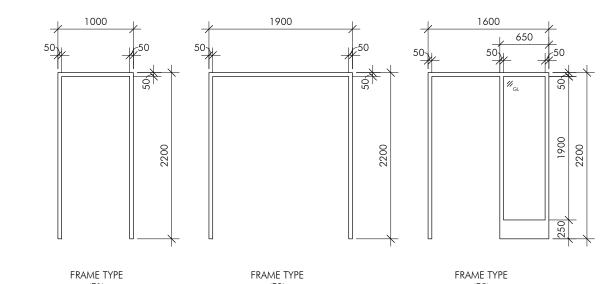

Door Frame Type Legend

scale = 1:50

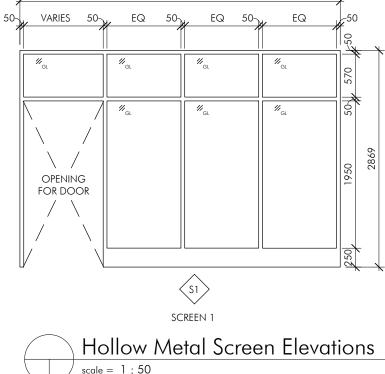

CONSTRUCTION ASSEMBLY LEGEND & NOTES:

CONSTRUCTION ASSEMBLY TYPE TAG

— PARTITION TYPE DESIGNATION FIRE RATING/ ACOUSTIC DESIGNATION FIRE RATING DESIGNATIONS: 'A' indicates 0 HR / NON-RATED FIRE SEPARATION 'B' indicates 30 MIN F.R.R. FIRE SEPARATION 'C' indicates 45 MIN F.R.R. FIRE SEPARATION 'D' indicates 1 HR F.R.R. FIRE SEPARATION 'E' indicates 1.5 HR F.R.R. FIRE SEPARATION 'F' indicates 2 HR F.R.R. FIRE SEPARATION ACOUSTIC DESIGNATIONS:

'Y' indicates ACOUSTIC DESIGNATION

FLOOR AND ROOF CONSTRUCTION ASSEMBLIES:

- REFER TO THE ONTARIO BUILDING CODE MATRIX, FIRE SEPARATION PLANS AND NOTES FOR LOCATIONS OF REQUIRED ROOF AND/OR FLOOR ASSEMBLIES REQUIRED TO HAVE A FIRE RESISTANCE RATING.
- PENETRATIONS INTO AND THROUGH ASSEMBLIES REQUIRED TO HAVE A FIRE RESISTANCE RATINGS ARE TO BE SEALED WITH AN APPROVED FIRE STOPPING MATERIAL THAT MEETS THE REQUIREMENTS OF THE SPECIFICATIONS.

INTERIOR WALL CONSTRUCTION ASSEMBLIES:

- ALL INTERIOR WALL PARTITIONS ARE TO EXTEND FROM FLOOR TO UNDERSIDE OF PRECAST / METAL DECK FLOOR OR ROOF STRUCTURE ABOVE UNLESS OTHERWISE NOTED.
- REFER TO FIRE SEPARATION PLANS FOR THE LOCATION AND RATING OF ALL REQUIRED FIRE SEPARATIONS. ALL PENETRATIONS INTO AND THROUGH FIRE SEPARATIONS ARE REQUIRED TO BE SEALED WITH AN APPROVED FIRE STOPPING MATERIAL. NOTE NOT ALL PARTITIONS IDENTIFIED WITH A ULC ratings are required to be constructed as fire separations only those indicated on the FIRE SEPARATION PLANS ARE REQUIRED TO MEET THE ULC DESIGNATION.
- ANY RECESSED MECHANICAL AND/OR ELECTRICAL PANELS, HEATERS AND/OR DEVICES (INCLUDING BUT NOT LIMITED TO ELECTRICAL PANELS, FIRE ALARM PANELS/PHONES, FIRE HOSE/EXTINGUISHER CABINETS, ETC....) SHOWN ON OR IN THE MECHANICAL & ELECTRICAL DOCUMENTS THAT ARE TO BE INSTALLED INTO A REQUIRED FIRE SEPARATION IS TO HAVE THE RECESSED LINED/WRAPPED WITH GYPSUM BOARD EQUIVALENT TO THE THICKNESS OF THE REQUIRED PARTITION THAT THE OPENING IS PLACED ON. (ie. IF THE PARTITION REQUIRES 2 LAYERS OF 16mm TYPE X' GYPSUM BOARD THEN THE RECESS WOULD REQUIRE 2 LAYERS OF TYPE 'X' GYPSUM BOARD)
- INTERIOR PARTITIONS THAT ARE NOT CLEARLY IDENTIFIED IN THE DRAWINGS OR DOCUMENTS ARE TO BE ASSUMED TO BE A "P2m" WALL TYPE.
- WHERE WALL ARE ACOUSTICALLY DESIGNATED, ACOUSTICAL SEALANT TO BE APPLIED AT TOP OF WALL

ABBREVIATIONS

ADL	ADDICEVIATIONS							
ACT	ACOUSTIC CEILING TILE	OC	ON CEN					
AFF	ABOVE FINISHED FLOOR	O/F	OUTSIDE					
ALUM	ALUMINUM	O/H	OVER HE					
BF	BARRIER FREE	OV	OVEN					
BLKHD	BULKHEAD	OWSJ	OPEN W					
CB	CATCH BASIN	PLAM	PLASTIC					
C/C	CENTER TO CENTER	PLY	PLYWOO					
CG	CORNER GUARD	PORC	PORCEL/					
CHR	CHAIR RAIL	PT	PRESSUR					
CL	CENTERLINE	PTD	PAINTED					
CMU	CONCRETE MASONRY UNIT	PV	PLUMBIN					
COL	COLUMN	R	range					
CP	COMMUNICATION PANEL	RA	ROOF A					
CLEAR	CLEAR FINISH	RB	RUBBER I					
CONC	CONCRETE	RCCF	REINFOR					
CPT	CARPET	RD	ROOF D					
CT	CERAMIC TILE	RM	REMOVA					
C/W	COMPLETE WITH	R.O.	ROUGH					

DRYER DRINKING FOUNTAIN RSV DISH WASHER RUB EXPANSION JOINT R/W RWL SCJ ELEVATION ELECTRICAL PANEL **EPOXY** SOLID SURFACE EYE WASH STATION SHOWER EXISTING SIMILAR EXPOSED SEALER REFRIGERATOR FIRE ALARM

FLOOR DRAIN FINISH FINISHED FACE STR GAUGE GALVANIZED TEMP GYPSUM BOARD hand sink HARDWOOD FLOORING HOLLOW METAL HOLD OPEN HEIGHT LAMINATE FLOORING

LINOLEUM KEYED CONSTRUCTION JOINT MATERIAL MAX MAXIMUM MINIMUM MASONRY OPENING METAL MICROWAVE MOP SINK

LAMINATED GLASS

FABRIC

NOT APPLICABLE NFHB NON-FREEZE HOSE BIBB NOT IN CONTRACT NOT TO SCALE

WEB STEEL JOIS CLAMINATE URE TREATED SING VENT ANCHOR ORCED CONCRETE CORE FILL VABLE MULLION H PENNING **ROD & SHELF** RESILIENT SHEET VINYL RUBBER FLOORING REINFORCED WITH rain water leader SAW CUT CONTROL JOINT

CONCRETE SPLASH PAD STAINLESS STEEL STONE TILE SHORT THROW PROJECTOR STAIR TREAD Stain & Varnish SOLID WOOD CORE TACK BOARD TEMPORARY TERRAZZO TEMPERED GLASS TOP OF Transition strip TYPICAL UNDER COUNTER U/C UNDERSIDE OF VINYL COMPOSITE TILE VWC VINYL WALL COVERING

Washing machine W/R WASHROOM WAIN WAINSCOT WHITE BOARD WINDOW COVERING WOOD WG WIRED GLASS

XX - DETAIL NUMBER

SHEET NUMBER WHERE

DETAIL IS DRAWN

- SHEET NUMBER WHERE

DETAIL REFERENCE FOUND

""4""	2017.09.07	Issued for Tender
"3"	2017.08.22	Issued for Tender
"2"	2017.08.09	Revision as per Meeting #3
"]"	2017.07.27	Revision as per Owner Rev
"0"	2017.07.17	Issued for 100% Review
REVISION	DATE	DESCRIPTION
SEALS:	ASSOCITION DE PRINCIPAL DE PRIN	ANOZ LEE

LICENCE 7178

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BETTER PLACES FOR PEOPLE www.formarchitecture.ca

PROJECT NAME:

CBRE - LU Chancellor Paterson Library

Teachers Common Renovations

955 Oliver Rd

SHEET TITLE:

Construction Assemblies, Legends & General Notes

Thunder Bay, ON

PROJECT:	2017024
DRAWN:	SLP/SRP
DATE:	August 2017

		Flo	or			1	W	alls					Ceiling	1		Millwo	rk	
				N	orth	E	ast		outh		est_							Comments
NO	ROOM NAME	Mat'l	Base	Mat'l	Finish	Mat'l	Finish	Mat'l	Finish	Mat'l	Finish	Mat'l	Finish	Height	Upper	Lower	Counter	
002	EXIST. CLASSROOM	LIN-1	RB1	EXIST	PTD	EXIST	PTD	EXIST	PTD	EXIST	PTD	ACT		EXIST				exist suspended ceiling to remain
003	WORKSPACE	CPT1	RB1	EXIST/G YP/-	PTD	EXIST/G YP	PTD	EXIST/G YP	PTD	EXIST/G YP	PTD	ACT	-	2743.2/33 52.8	-	-	-	
5003A	OFFICE	CPT1	RB1	GYP	PTD	GYP	PTD	EXIST	PTD	GYP	PTD	ACT	-	2743.2	-	-	-	Sound batt above ACT
003B	OFFICE	CPT1	RB1	GYP	PTD	GYP	PTD	GYP	PTD	GYP	PTD	ACT	-	3352.8	-	-	-	Sound batt above ACT
5003C	EXIST. IT RM	-	-	EXIST	N/A	-/GYP	PTD	-/GYP	PTD	EXIST	N/A	ACT	-	2743.2	-	-	-	Match exist. adjacent finishes
003D	CONFERENCE	CPT1	RB1	GYP	PTD	EXIST	PTD	EXIST/G YP	PTD	GYP	PTD	ACT	-	3352.8	-	-	-	Sound batt above ACT
003E	OFFICE	CPT1	RB1	GYP	PTD	GYP	PTD	GYP	PTD	GYP	PTD	ACT	-	3352.8	-	-	-	Sound batt above ACT
003F	OFFICE	CPT1	RB1	GYP	PTD	GYP	PTD	GYP	PTD	GYP	PTD	ACT	-	3352.8	-	-	-	Sound batt above ACT
003G	COLLABORATION	CPT1	RB1	EXIST	PTD	EXIST	PTD	-	-	GYP	PTD	ACT	-	2743.2	-	-	-	
003H	MEETING	CPT1	RB1	EXIST	PTD	GYP	PTD	GYP	PTD	EXIST	PTD	ACT	-	2743.2	-	-	-	Sound batt above ACT
003J	OFFICE	CPT1	RB1	GYP	PTD	GYP	PTD	GYP		EXIST	PTD	ACT	-	2743.2	-	-	-	Sound batt above ACT
003K	OFFICE	CPT1	RB1	GYP	PTD	GYP	PTD	EXIST	PTD	GYP	PTD	ACT	-	3352.8	-	-	-	Sound batt above ACT
003L	OFFICE	CPT1	RB1	GYP	PTD	GYP	PTD	GYP		GYP	PTD	ACT	-	3352.8	-	-	-	Sound batt above ACT
003M	COFFEE	LVT1	RB1	GYP	PTD	-	-	EXIST	PTD	EXIST	PTD	ACT	-	2743.2	WD	WD	PLAM	
005	EXIST. LOUNGE	LVT1	RB1	EXIST	PTD	EXIST	PTD	GYP	PTD	EXIST/G YP	PTD	ACT	-	2743.2	WD	WD	PLAM	
5005a	GREEN ROOM	CPT1	RB1	GYP	PTD	EXIST/G YP	PTD	EXIST	PTD	EXIST	PTD	ACT	-	2743.2	-	-	-	
5006	EXIST. OFFICE	-	-	-/GYP.	PTD	-	-	-	-	-	-	ACT	N/A	EXIST	-	-	-	Match exist. adjacent finishes
(5010	EXIST. CORRIDOR	-	-	-	-	-	-	-	-	-	PTD	ACT	N/A	EXIST	-	-	-	Match exist. adjacent finishes
5011	EXIST. LOBBY	-	-	-	-	-	-	-	-	-	PTD	ACT	N/A	EXIST	-	-	-	Match exist. adjacent finishes
5012	EXIST. CORRIDOR	-	-	-/GYP.	PTD	-	-	-/GYP	PTD	-	-	ACT	N/A	EXIST	-	-	-	Match exist. adjacent finishes

Room Finish Schedule - New Construction

GENERAL NOTES

- ALL DIMENSIONS TO BE VERIFIED ON SITE
- DOUBLE STUD AROUND OPENINGS IN EXCESS OF 400m2


CONTRACTOR TO COORDINATE ALL MECHANICAL AND ELECTRICAL WORK WITH ARCHITECTURAL.

DETAILS BUILDING SECTION EXTERIOR BUILDING ELEVATION - DETAIL NUMBER SHEET NUMBER WHERE DRAWN

INTERIOR BUILDING ELEVATION - DETAIL NUMBER SHEET NUMBER WHERE DRAWN





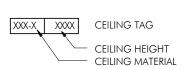

Level Name Elevation ELEVATIONS/DATUMS






INTERIOR/EXTERIOR WALL TYPE TAG PARTITION TYPE - FIRE RATING DESIGNATION

WINDOW/LOUVER TYPE TAG







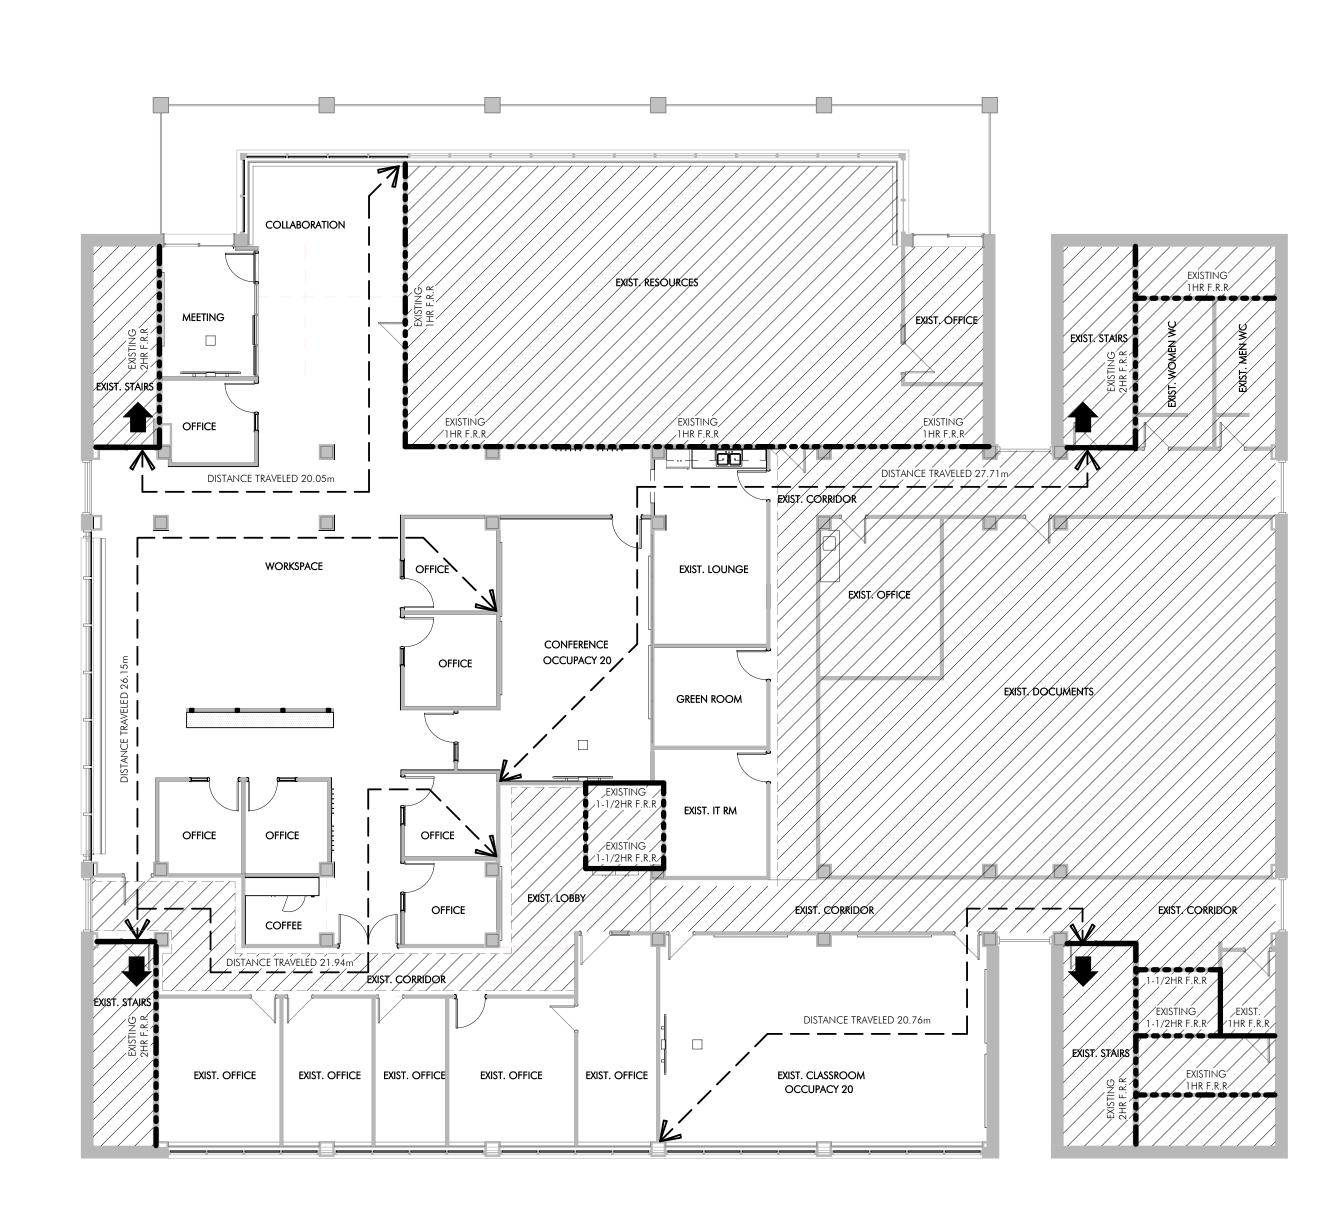


Level 1 - Existing Fire Separation Plan


A2.4 A0.2 scale = 1:125

				.5582 phone marchitecture.ca	NDER BAY, ON 1 807.345.4093 fa							
NAME C	CATE OF PRACTICE N	UMBER:	4821									
	OF PROJECT:				ancellor Peterson nmon Renovations							
PROJEC	CT LOCATION:				er Bay, ON P7B 5							
LEGAL D	description:		-									
ITEM				006 BUILDING C						OBC REFE	on B unl	
1	PROJECT DESCRIPTION	DN:			□ NEW	X PART 1	1	□ P	[A] for Di	vision A or [C	1	ART 9
					☐ ADDITION	11.1 TO 1	1.4	1.1.2	2. [A]			2. [A] & .1.3.
2	MAJOR OCCUPANC	Y(S): GRC		ange of use	X ALTERATION			3.1.2	2.1.(1)		9.10	.2
3	BUILDING AREA (mete			√G 2397.7 m2	NEW	TOTAL 239	7.7 m2	1.4.	1.2. [A]		1.4.	1.2. [A]
	GROSS AREA (meters			G 2397.7 m2		TOTAL 239			1.2. [A]			1.2. [A]
	NUMBER OF STOREY			GRADE SIX	BELOW	GRADE N /	′A		1.2. [A] & 3 2.10 & 3.2		9.10	1.2.[A] & 9.10
	BUILDING CLASSIFIC			ING - NON SPR					2.10 & 3.2 2.2083		9.10	
8	SPRINKLER SYSTEM PI				TRE BUILDING			3.2.2	2.2083			.8.2.
				☐ SELE	ECTED COMPART			3.2.	1.5			
				□ BAS		LIEU OF ROC	OF RATING				INDE	EX
9	STANDPIPE REQUIRE)	EXISTING		¥ YES □ N	0		3.2.9	9		N/A	
	FIRE ALARM REQUIRE		EXISTING		YES N			3.2.4			9.10	.18.
11	WATER SERVICE/SUPI	PLY IS ADE	QUATE	EXISTING EXISTING	☐ YES ☐ N			3.2.5			N/A	
12	HIGH BUILDING CONSTRUCTION RES	STRICTION	ıs 🗆 (COMBUSTIBLE	YES NON-COM		□ вотн	3.2.0	3 2.2083		9.10	
	ACTUAL CONSTRUCT		١.	PERMITTED COMBUSTIBLE	REQUIRED NON-COM		□ вотн	/	.55			
	mezzanine(s) area	(meters sq					N/A	3.2.	1.1.(3)-(8)		9.10	.4.1
15	OCCUPANT LOAD BA			AREA	M DESIGN OF	BUILDING		3.1.	17		9.9.	1.3
	1st FLOOR: N/A 5 2nd FLOOR: N/A	th FLOOR		CUPANCY	LOAD LOAD	perso						
	3rd FLOOR: N/A OCCUPANCY LOAD pe											
	4th FLOOR: N/A			CUPANCY	LOAD	pers						
	FOR ADDITIONAL FLO	OORS (IF I	REQUIRED), REFER TO BEL	.OW							
16	BARRIER-FREE DESIGN			YES NO	(EXPLAIN)			3.8			9.5.2	
17	HAZARDOUS SUBSTA			YES NO	TIST	ED DESIGN N	IO		1.2 & 3.3. 2.2083 &		9.10	.1.3(4)
	FIRE	110	FRR (HC			ESCRIPTION (0.2.2	2.20 .00 0	. 0.2.1.1	9.10	
	resistance	FLOORS		hours 2 hr.	REFER TO F	LOOR ASSEM	ABLIES					
	rating	ROOF		hours 1 hr.								
	(FRR)	MEZZAN		HOURS N/A PPORTING	TIST	ED DESIGN N	10					
		'	MEME			ESCRIPTION (
	-	FLOORS		HOURS 2 HR.	REFER TO A	,	. ,	1				
		ROOF		hours 1 hr .								
10	CDATIAL CEDADATION	MEZZAN		HOURS N/A	VALLS EXPORTS	NO OIIII	CF	0.0	<u> </u>		10.75	1.4
19	SPATIAL SEPARATION WALL AREA OF		L/H OR	PERMITTED	VALLS EXISTING PROPOSED	- NO CHAN	GE LISTE	3.2.3 ED	3 COMB.	СОМ	9.10 B.	NON-COM
	EBF (m2)	(m)	H/L	MAX. % OF OPENINGS	% OF OPENINGS	(HOURS)		N OR	CONST.	CONSTR. N	NONC.	CONSTR.
	NORTH											
[SOUTH											
-	EAST WEST											
+	FOR ADDITIONAL WA	ALLS (IF NE	CESSARY)	, REFER TO BELO	 DW							
	PLUMBING FACILITIES					UPANCY						
	OCCUPANCY TYPE				UPANCY COUNT		REQU	JIRED \	WATER CL	OSET COUN	IT	
F												
-												
+	LAVATORY COUNTS:					I						
	2 2 3											
21	OTHER - DESCRIBE: 1	RAVFI DIS	STANCE FO	OR FIRE SEPARAT	TION AND FYISTII	NG BLIII DINIC	DESCRIPT	ION				
	3.4.2.4 - TRAVEL DIST			ON TIME SELLANA		. DOILDING	, DEJUNIT I	1011				
	6 STOREY BUILDING	HEIGHT	<u>cb 1993)</u>									
	GROUP A - DIVISION NON-COMBUSTIBLE	CONSTRU										
	FLOOR ASSEMBLIES -	2hr F.R.R.		- 2hr F.R.R.								
	5511 5111110 66		ILJ -	1 . IX.IX.								

ONTAK	TO BUILDING CODE DATA MA	NTRIX - PART 11 - RENOVATION OF EXISTING BUILDING	REFE
11.1	EXISTING BUILDING	DESCRIBE EXISTING USE: GROUP 'A2' - ASSEMBLY	11.2.1
	CLASSIFICATION:	CONSTRUCTION INDEX:	T 11.2
		HAZARD INDEX:	T 11.2
		NOT APPLICABLE (NO CHANGE OF MAJOR OCCUPANCY)	TON
11.2	ALTERATION TO EXISTING	BASIC RENOVATION	11.3.3
	BUILDING IS:	EXTENSIVE RENOVATION	11.3.3
11.3	REDUCTION IN		11.4.2
	PERFORMANCE LEVEL:	STRUCTURAL: ■ NO □ YES	11.4.2
		BY INCREASE IN OCCUPANT LOAD: ▼ NO	11.4.2
		BY CHANGE OF MAJOR OCCUPANCY: NO	11.4.2
		PLUMBING: ■ NO □ YES	11.4.2
		SEWAGE-SYSTEM: NO YES	11.4.2
11.4	COMPENSATING		11.4.3
	CONSTRUCTION:	STRUCTURAL: NO YES (EXPLAIN)	11.4.3
		INCREASE IN OCCUPANT LOAD: NO YES (EXPLAIN) OCCUPANCY OF 5th FLOOR IS NOTED AS 45 ON EXISTING DRAWINGS. EXISTING FIXTURES: 2 MALE, 2 FEMALE PER 3.7.4.3A OBC: THIS FIXTURE COUNT IS COMPLIANT WITH THE CURRENT	11.4.3
		OCCUPANT COUNT OF 60 (30 MALE, 30 FEMALE) CHANGE IN MAJOR OCCUPANCY: NO □ YES (EXPLAIN)	11.4.3
		PLUMBING: NO YES (EXPLAIN)	11.4.3
		SEWAGE SYSTEM: NO YES (EXPLAIN)	11.4.3
11.5	COMPLIANCE ALTERNATIVES PROPOSED:	NO □ YES (GIVE NUMBER(S)) □	11.5.1

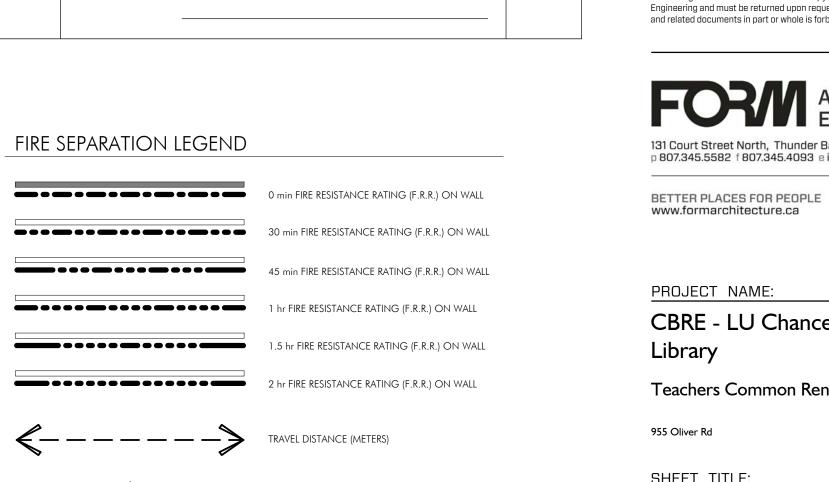

EXIT LOCATION

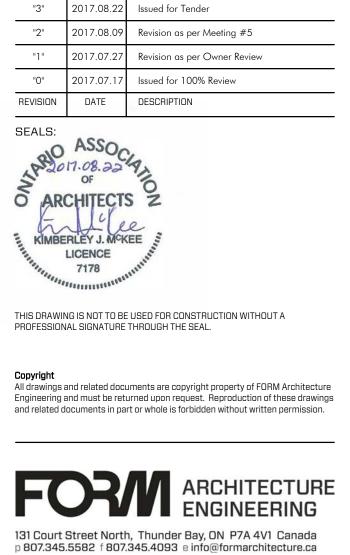

PROJECT NAME:
CBRE - LU Chancellor Patersor
Library
Teachers Common Renovations


955 Oliver Rd Thunder Bay, ON


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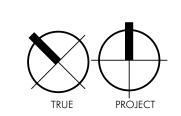
Fire Separation Diagrams

DATE:	August 2017
DRAWN:	SLP
PROJECT:	2017024





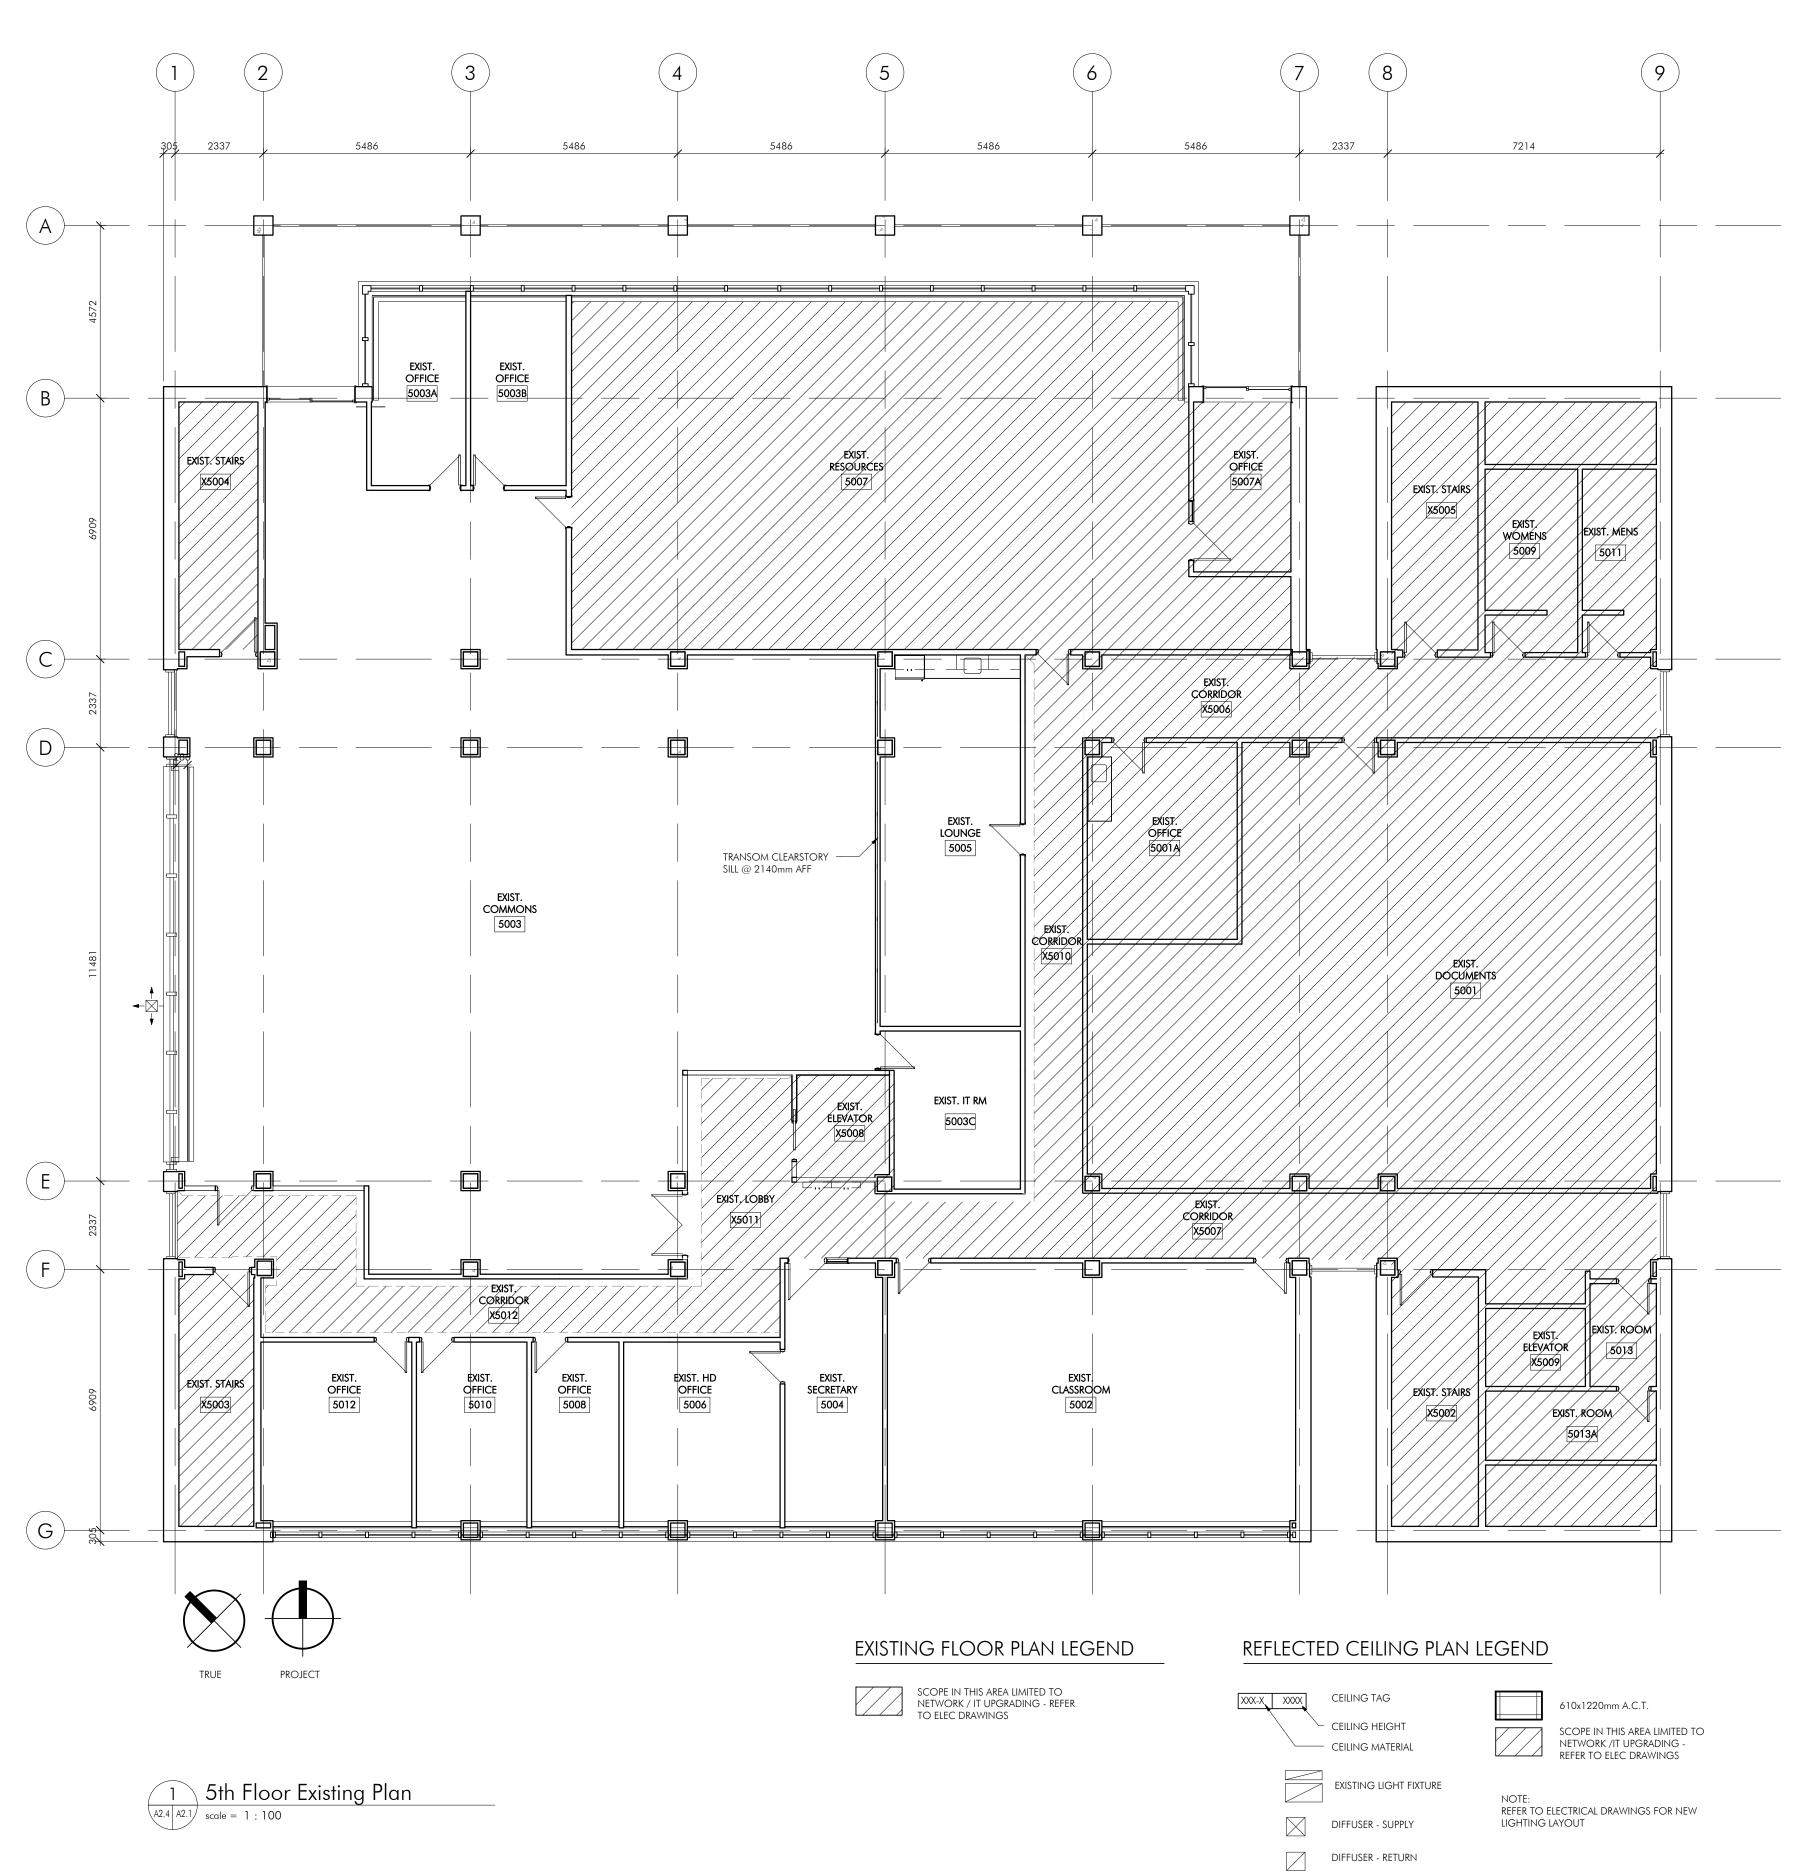

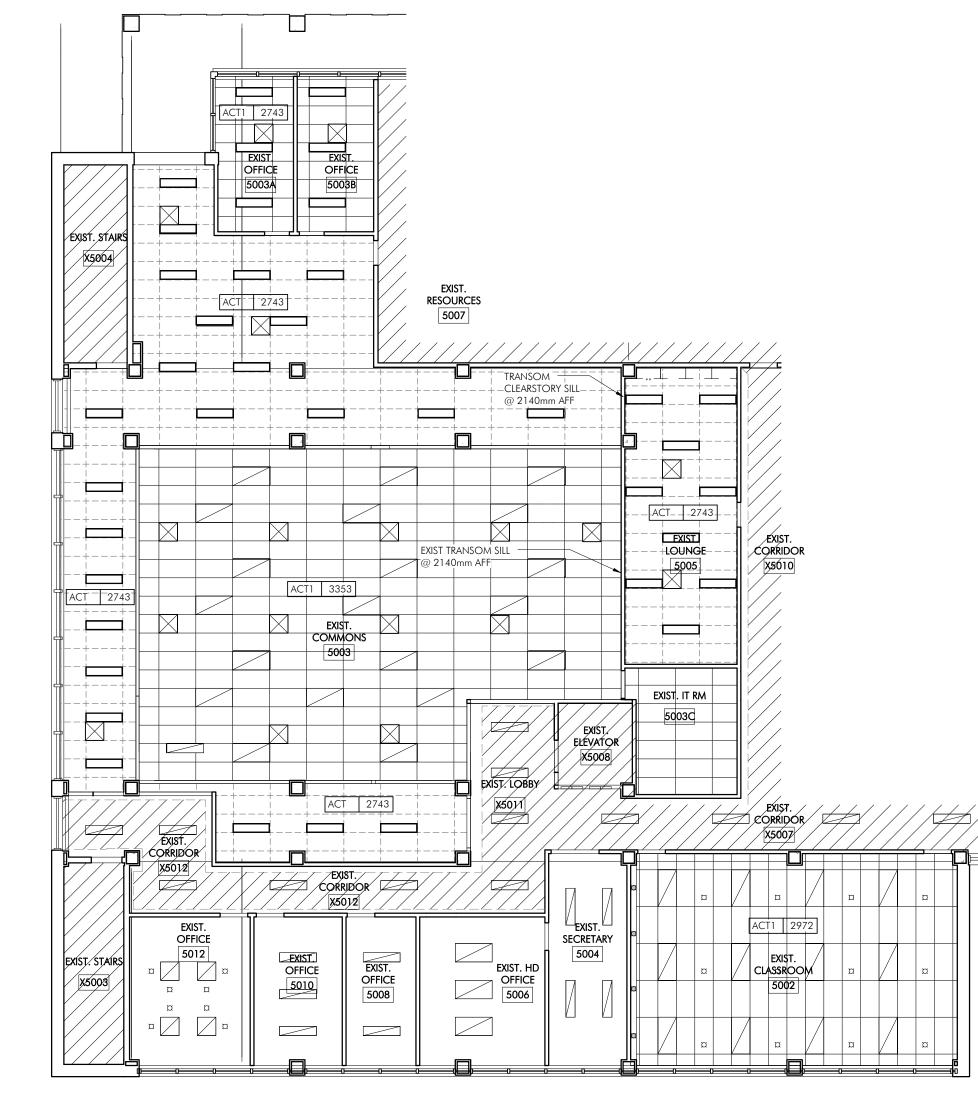

2 Sth Floor - Existing Reflected Ceiling Plan

A2.4 A2.1 scale = 1:125

"4"	2017.09.07	Issued for Tender
"3"	2017.08.22	Issued for Tender
"2"	2017.08.09	Revision as per Meeting #5
"]"	2017.07.27	Revision as per Owner Review
"0"	2017.07.17	Issued for 100% Review
REVISION	DATE	DESCRIPTION
SEALS:	ASSO _C	42

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PROJECT NAME:

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Library

Teachers Common Renovations


955 Oliver Rd Thunder Bay, ON

SHEET TITLE:

Existing Floor Plans and Reflected Ceiling Plans

PROJECT:	2017024
DRAWN:	SLP
DATE:	August 2017

A2.1

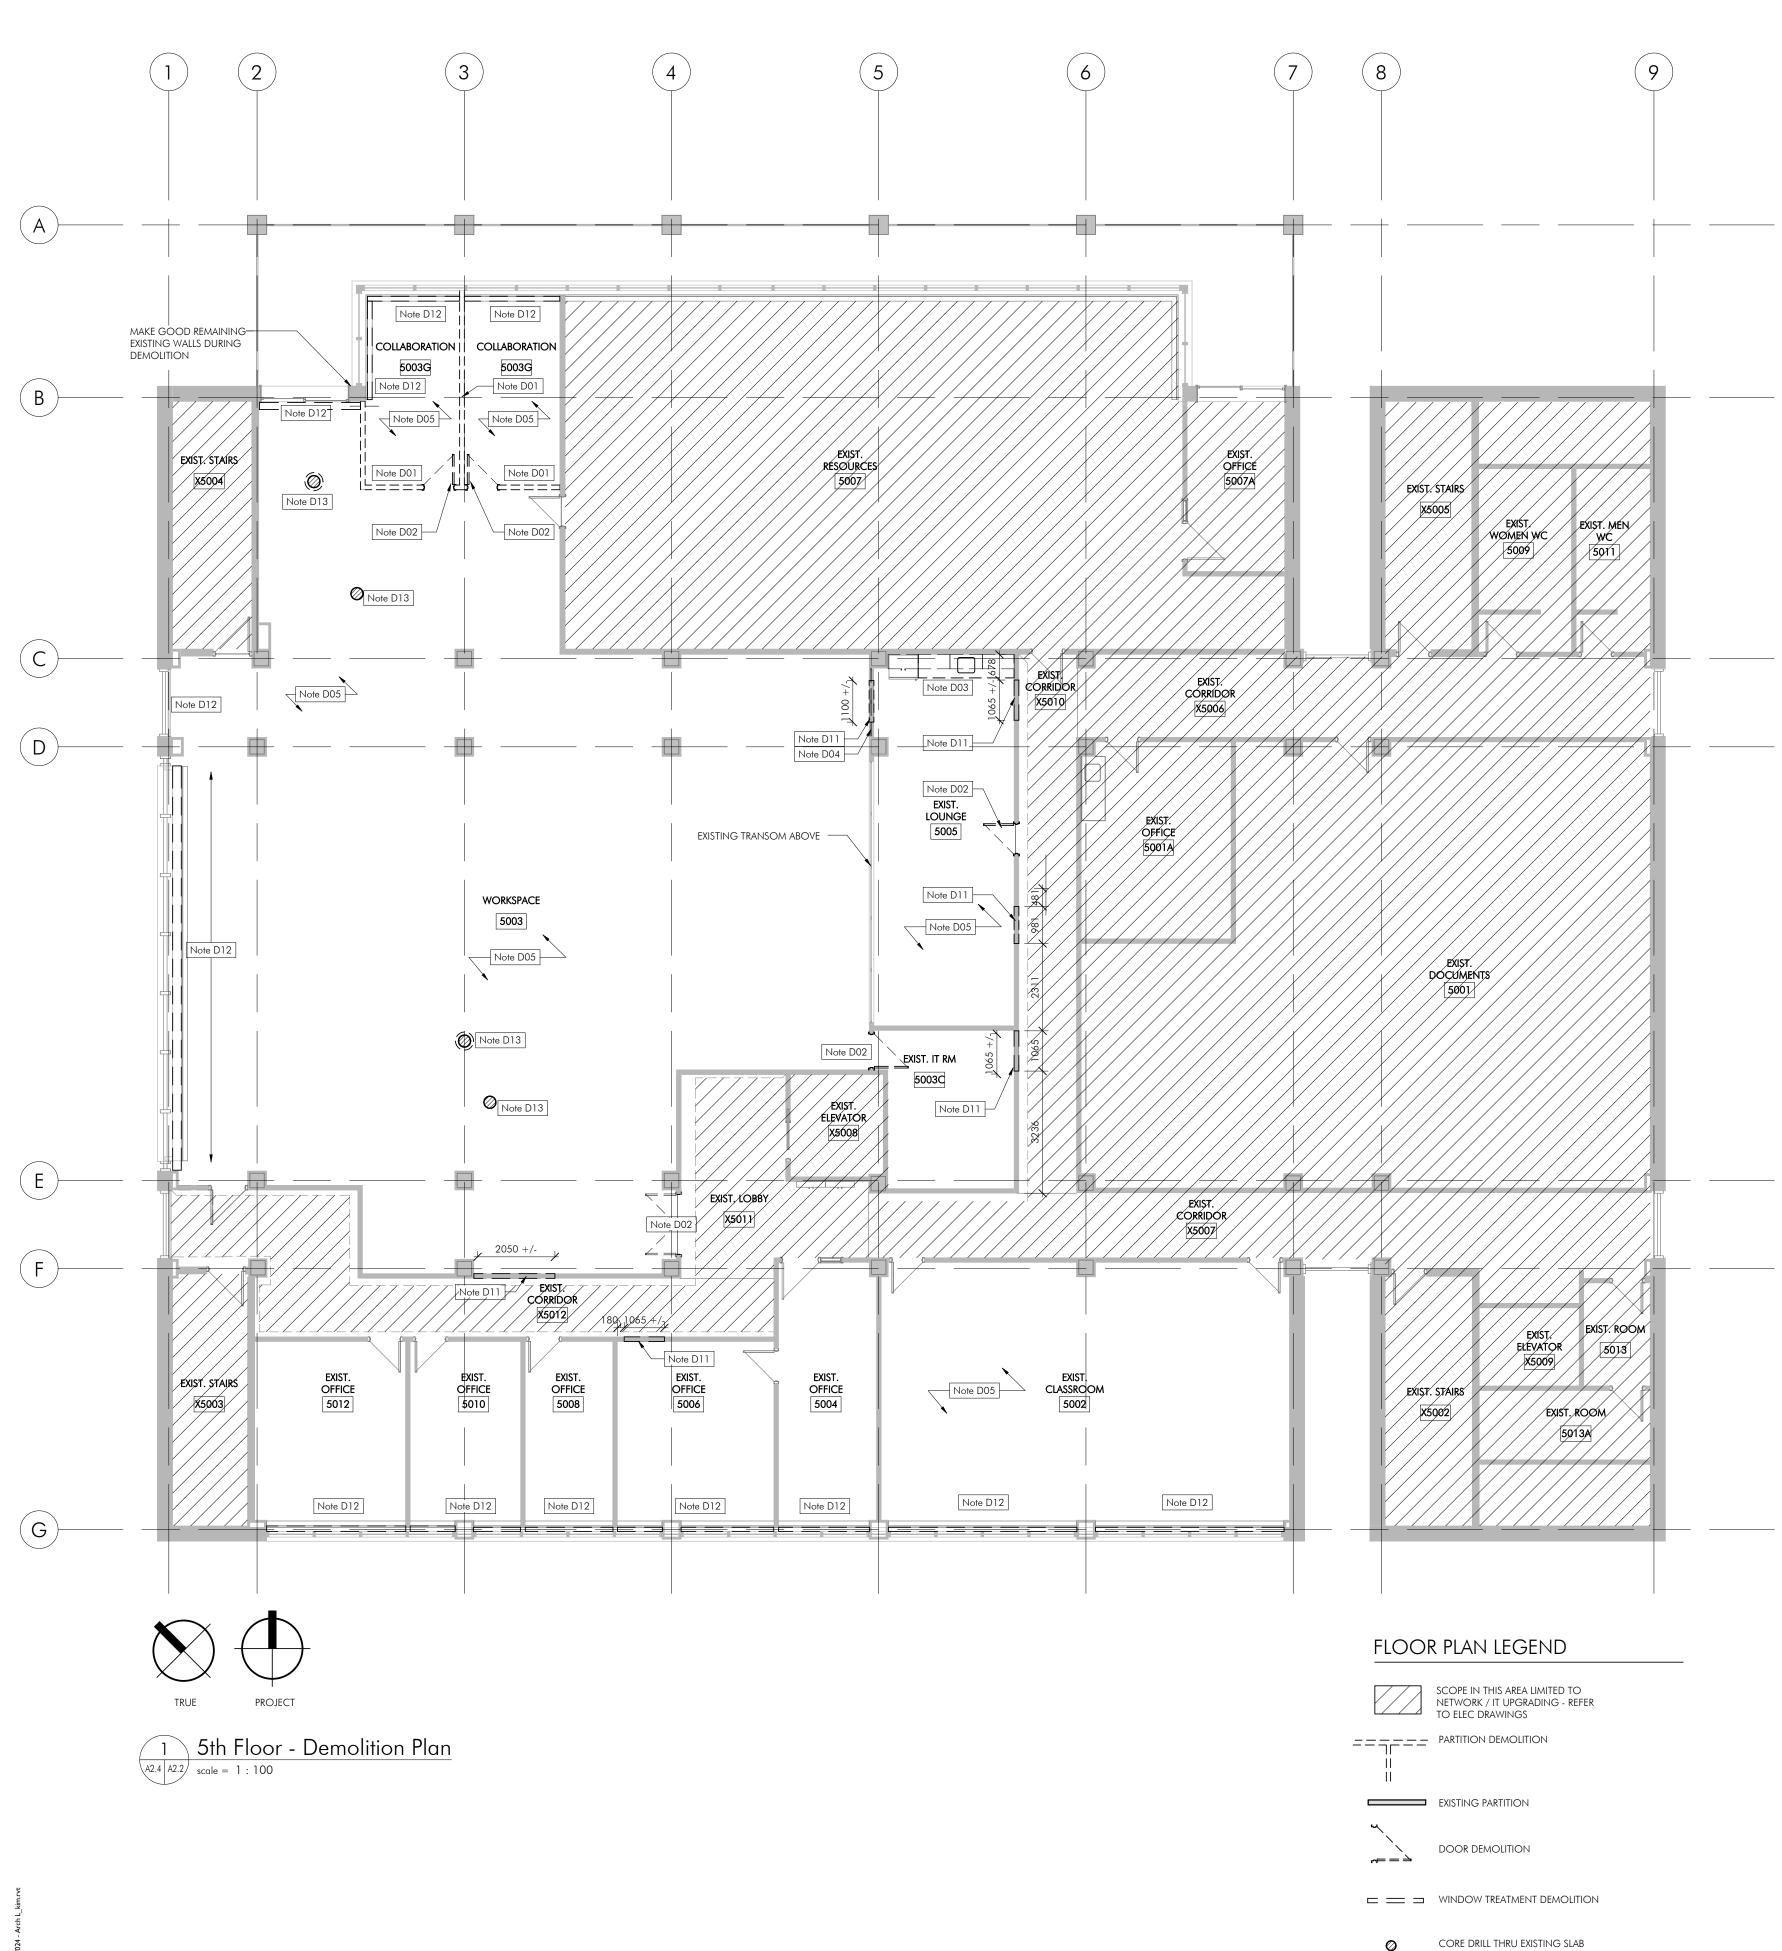

GENERAL DEMOLITION NOTES

- PATCH & MAKE GOOD FINISHED AFFECTED BY DEMOLITION - REMOVE & SALVAGE SIGNAGE, TACK BOARDS, & WALL MOUNTED NOTICE BOARDS - TURN OVER TO OWNER - REFER TO ELECTRICAL FOR LIGHTING DEMOLITION, SECURITY SYSTEM, SPEAKER SCOPE & IT / NETWORK SCOPE


- REFER TO MECHANICAL FOR GRILLE & DIFFUSER DEMOLITION SCOPE


- SITE VERITY ALL DIMENSIONS

- NO NOT SCALE DRAWINGS - REFER TO HAZARDOUS MATERIALS SURVEY & REMOVAL PROCEDURES IN SPECIFICATIONS PRIOR TO COMMENCING DEMOLITION



	Demolition Notes					
Mark	Description					
Note D01	Demolish wall to extent dimensioned on plan. Patch & make good adjacent surface affected by removal.					
Note D02	Demolish door and frame. Turn over to owner.					
Note D03	Demolish sink and millwork, no salvage. Make good and walls damaged during demolition.					
Note D04	Remove clerestorey window above demolished wall, make good surrounding walls.					
Note D05	Remove existing flooring, remove any bonding agents used. Clean and prep surface for new flooring.					
Note D06	Demolishing existing ceiling tiles in area of work. Refer to demolition plans, no salvage.					
Note D07	Remove eletrical for light fixture demolition. No Salvage.					
Note D08	Existing valance and bulkhead to remain. Refer to electrical for lighting demolition.					
Note D09	Existing gypsum bulkhead & framing to remain.					
Note D10	Demolish existing gypsum/metal frame bulkhead to extent shown, to suit new partition layout. Patch & make good surface affected by removal.					
Note D11	Create new opening in exisiting non load bearing wall to allow installation of new door & frame. Provide standard framing @ new opening. Refer to door & hardwar schedules. Patch & make good adjacent finishes.					
Note D12	Remove existing window blinds, support & valances. No salvage.					
Note D13	Core drill existing concrete slab to suit installation of new electrical. Coordinate location with electrical & furniture layout. Provide 48 hrs notice prior to drilling. Minimize dispruption to spaces below & protect areas from dust and water.					

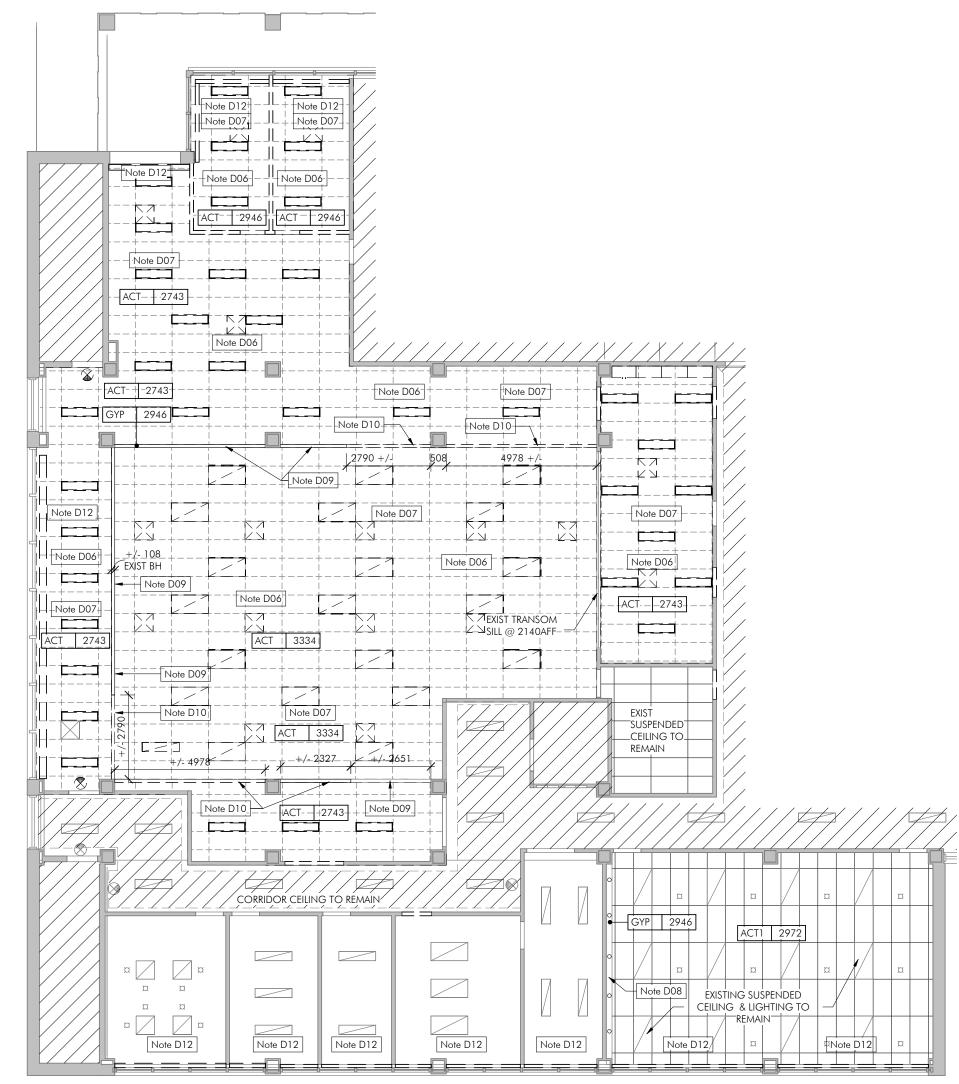

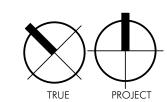

2 Sth Floor - Reflected Ceiling Plan - Demolition scale = 1:125



XXX-X XXXX CEILING TAG CEILING HEIGHT —— CEILING MATERIAL EXISTING LIGHT FIXTURE DIFFUSER - SUPPLY

SCOPE IN THIS AREA LIMITED TO NETWORK /IT UPGRADING - REFER TO ELEC.

REFER TO ELECTRICAL DRAWINGS FOR NEW LIGHTING LAYOUT

610x1220mm A.C.T.

DEMOLISH EXISTING A.C.T. & GRID

PROJECT: 2017024

"3" 2017.08.22 Issued for Tender "2" 2017.08.09 Revision as per Meeting #5 "1" 2017.07.27 Revision as per Owner Review Issued for 100% Review REVISION DATE DESCRIPTION THIS DRAWING IS NOT TO BE USED FOR CONSTRUCTION WITHOUT A PROFESSIONAL SIGNATURE THROUGH THE SEAL.

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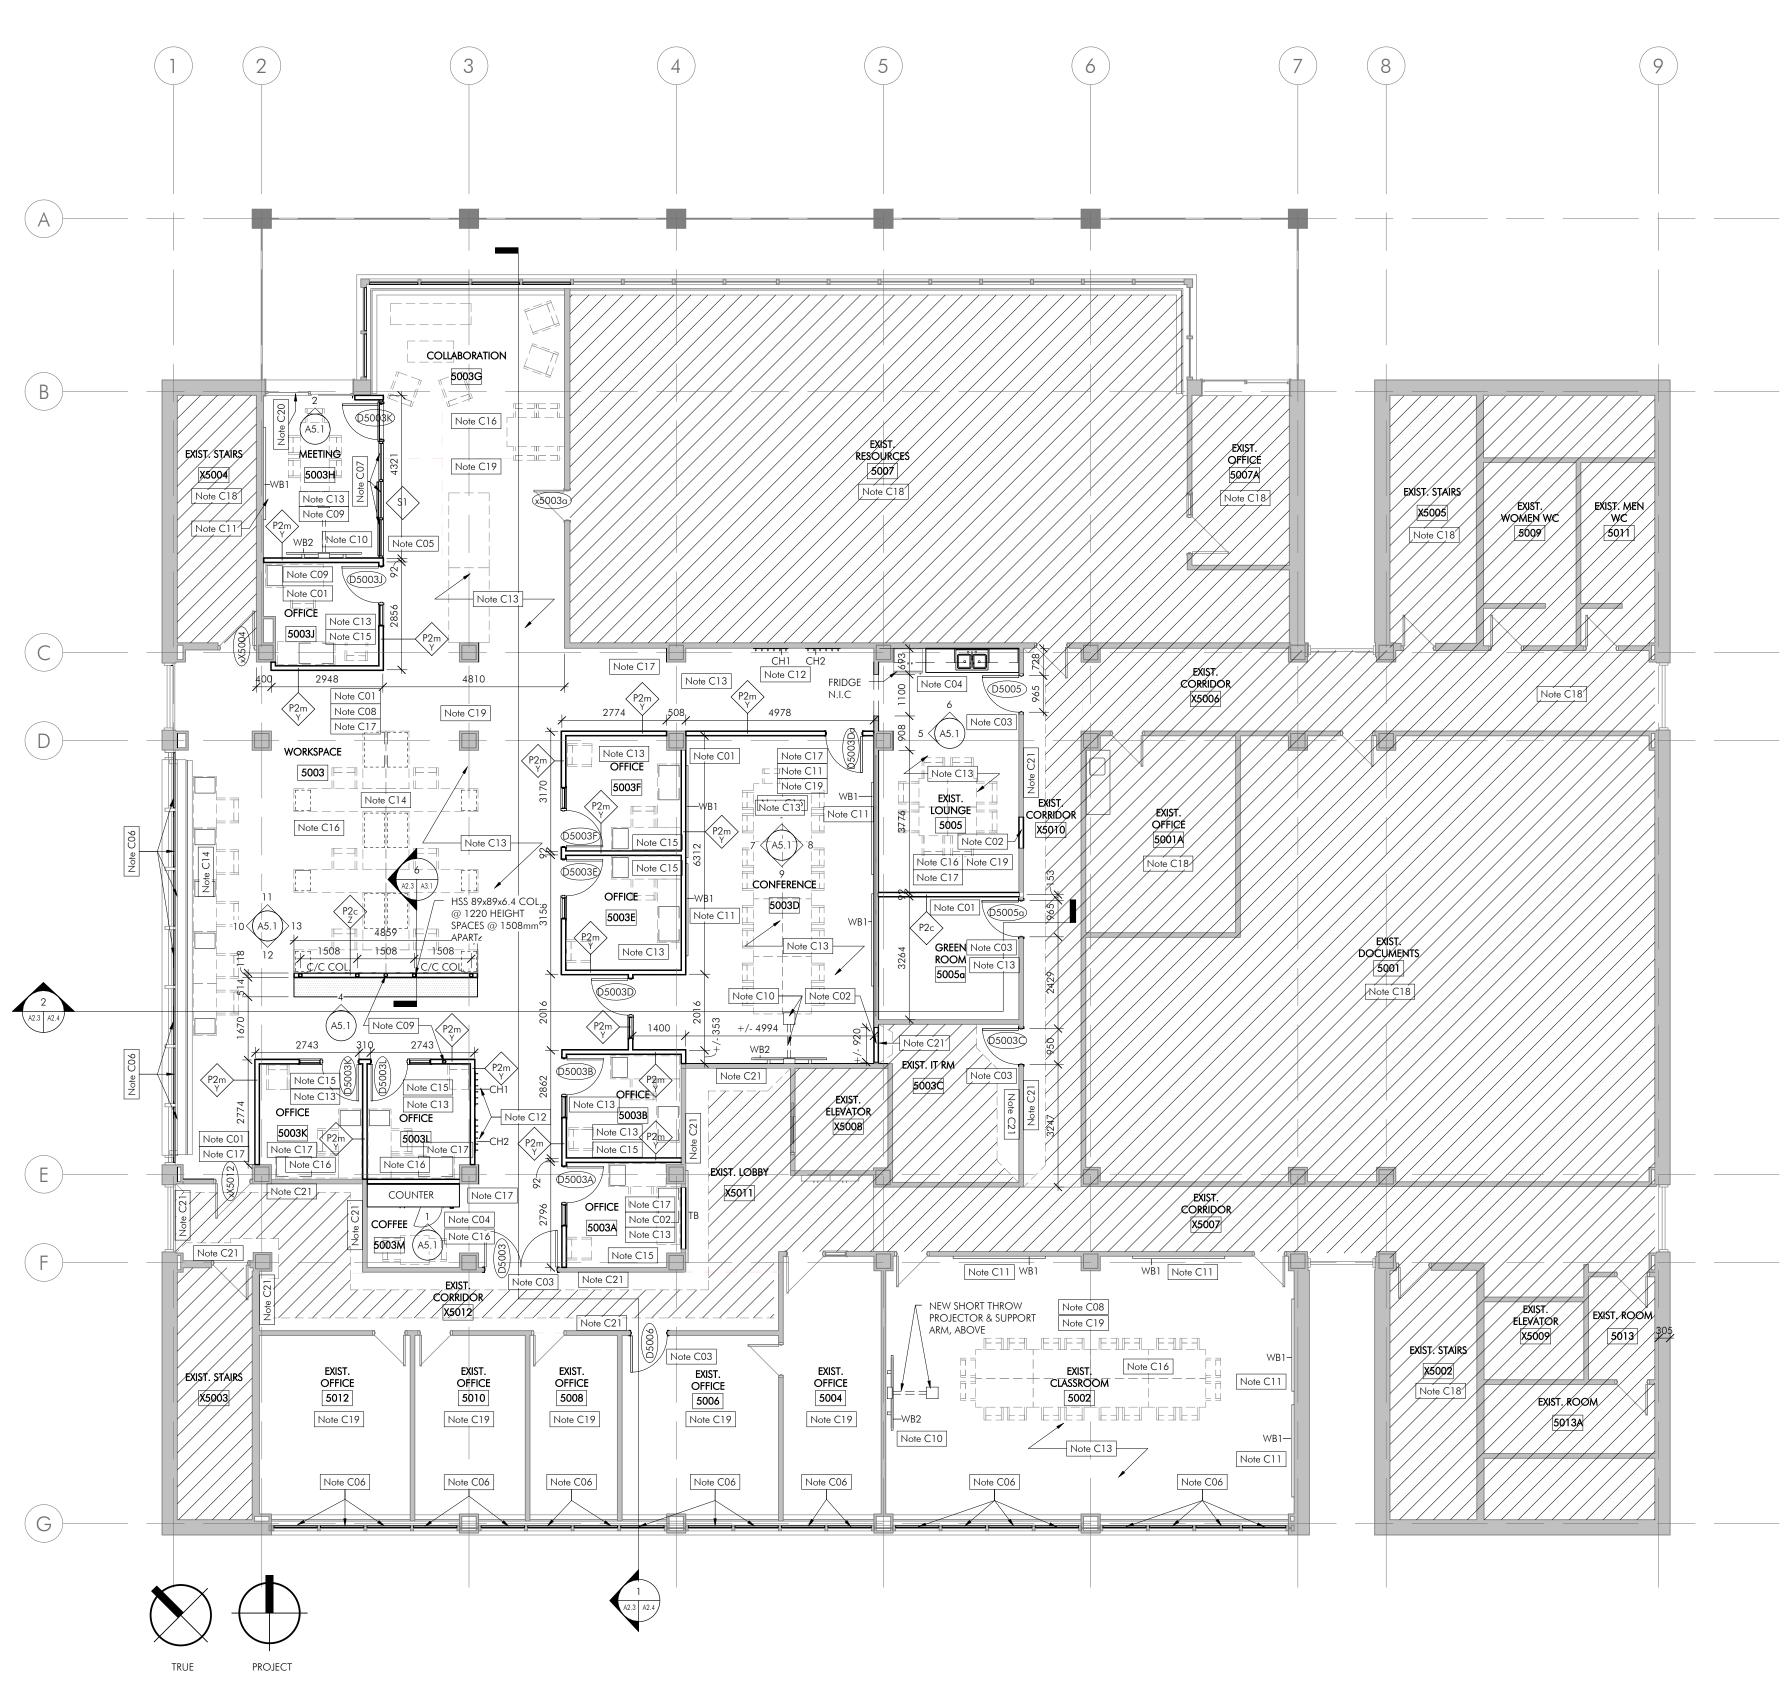
Thunder Bay, ON

955 Oliver Rd

SHEET TITLE:

Demolition Floor Plan, Reflected Ceiling Plan

DATE: August 2017




5th Floor - Renovation Plan


A2.4 A2.3 scale = 1:100

	Construction Notes
Mark	Description
Note C01	Construct new wall. Tie into existing walls & make surface flush. Make good any walls that were damaged during demolition. Refer to construction assemblies & room finished schdule.
Note C02	Construct infill wall at existing, depth to match exist wall so that surfaces are flush. Tie into existing walls, make good any walls that were damaged during demolition. Refer construction assemblies & room finishes schdule.
Note C03	Install new door, frame and hardware in new opening in existing wall. Refer to door and frame schedule.
Note C04	Install new cabinetry and millwork. See Sheet A6.1
Note C05	Supply and install new suspended ceiling. Refer to room finish schedule for extent of sound batt locations. hold back sound batt 150mm from recessed LED light fixtures.
Note C06	Supply and install new roller blinds at exterior windows. Refer to specifications.
Note C07	Supply and install new roller blinds at hollow metal screen.
Note C08	Apply new paint finish to existing walls, window frames, doors and door frames. Refer to finish plan for colour & specification for paint formula.
Note C09	Coordinate location of core drill for power/data with electrical and furniture supplier. Firestop to maintain 2hr. FRR floor assembly.
Note C10	Owner supplied projection whiteboard (WB2), support arm, and short throw projector. GC to install WB2 and solid blocking for short throw projector support arm. Owner to intall support arm and short throw projector. Coordinate location and mounting height of whiteboard and blocking with owner (LU-TSE) and electrical prior to installation.
Note C11	Supply and install new whiteboard (WB1) 2120mm AFF to top of board unless noted. Refer to specifications.
Note C12	Supply and install 6 coathooks mounted to solid birch backer plate @ 150mm O.C. fasten plate to solid substrate @ min. 3 locations. Counter sink and plug fasteners, eas all edges with clear coat. Install CH1 @ 1500mm AFF and, install CH2 (Barrier-free coat hooks) @ 1500mm AFF.
Note C13	Supply and install new floor finish. Refer to room finish schedule.
Note C14	Supply and install new system furniture. Coordinate with electrical, owner and furniture suplier. Refer to Sheet A7.1 for furniture layout. See specifications.
Note C15	Supply and install new case goods. coordinate with electrical, owners and furniture supplier. Refer to Sheet A7.1 for layout. See Specifications.
Note C16	Supply and install new non-fixed furniture. Refer to Sheet A7.1. See Specifications
Note C17	All existing columns in area of scope to recieve new paint finish, all exposed sides
Note C18	Scope in this room is limited to new IT / network. Refer to elec. Patch & make good finishes affected by this scope.
Note C19	Refer to elec drawings for new IT / network scope in this room. Patch & make good finishes affected by this scope.
Note C20	Supply and install new roller blinds at sliding door frame
Note C21	Apply new paint finish to existing corridor wall. Colour to match existing.

GENERAL CONSTRUCTION NOTES

- 1. ALL DIMENSIONS TO BE VERIFIED ON SITE
- 2. DO NOT SCALE DRAWINGS
- 3. READ ARCH. PLANS IN CONJUNCTION WITH MECH. AND ELEC.

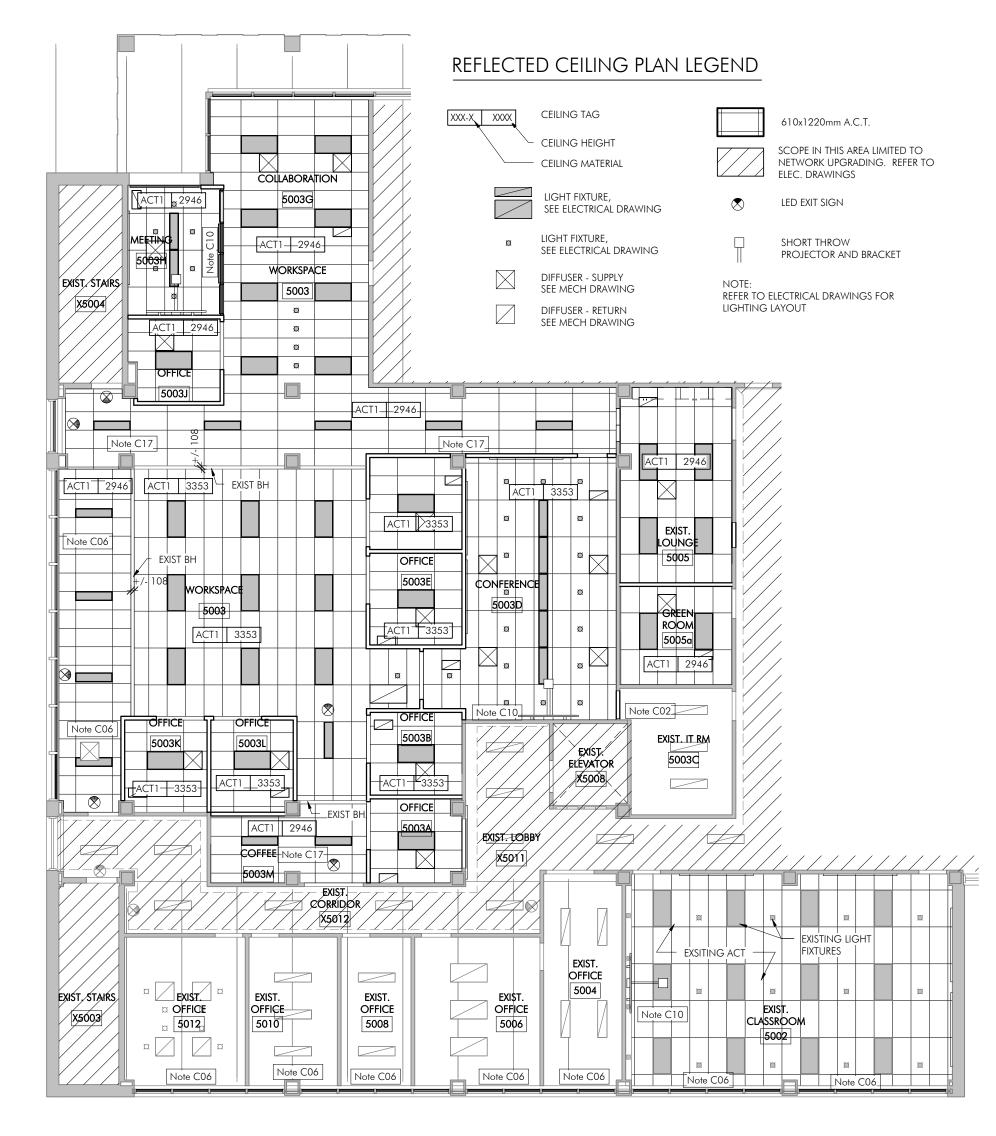

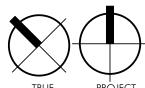

2 5th Floor - Reflected Ceiling Plan - Renovation

A2.4 A2.3 scale = 1: 125

"4"	2017.09.07	Issued for Tender
"3"	2017.08.22	Issued for Tender
"2"	2017.08.09	Revision as per Meeting #5
"]"	2017.07.27	Revision as per Owner Review
"0"	2017.07.17	Issued for 100% Review
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PROJECT NAME:

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Teachers Common Renovations

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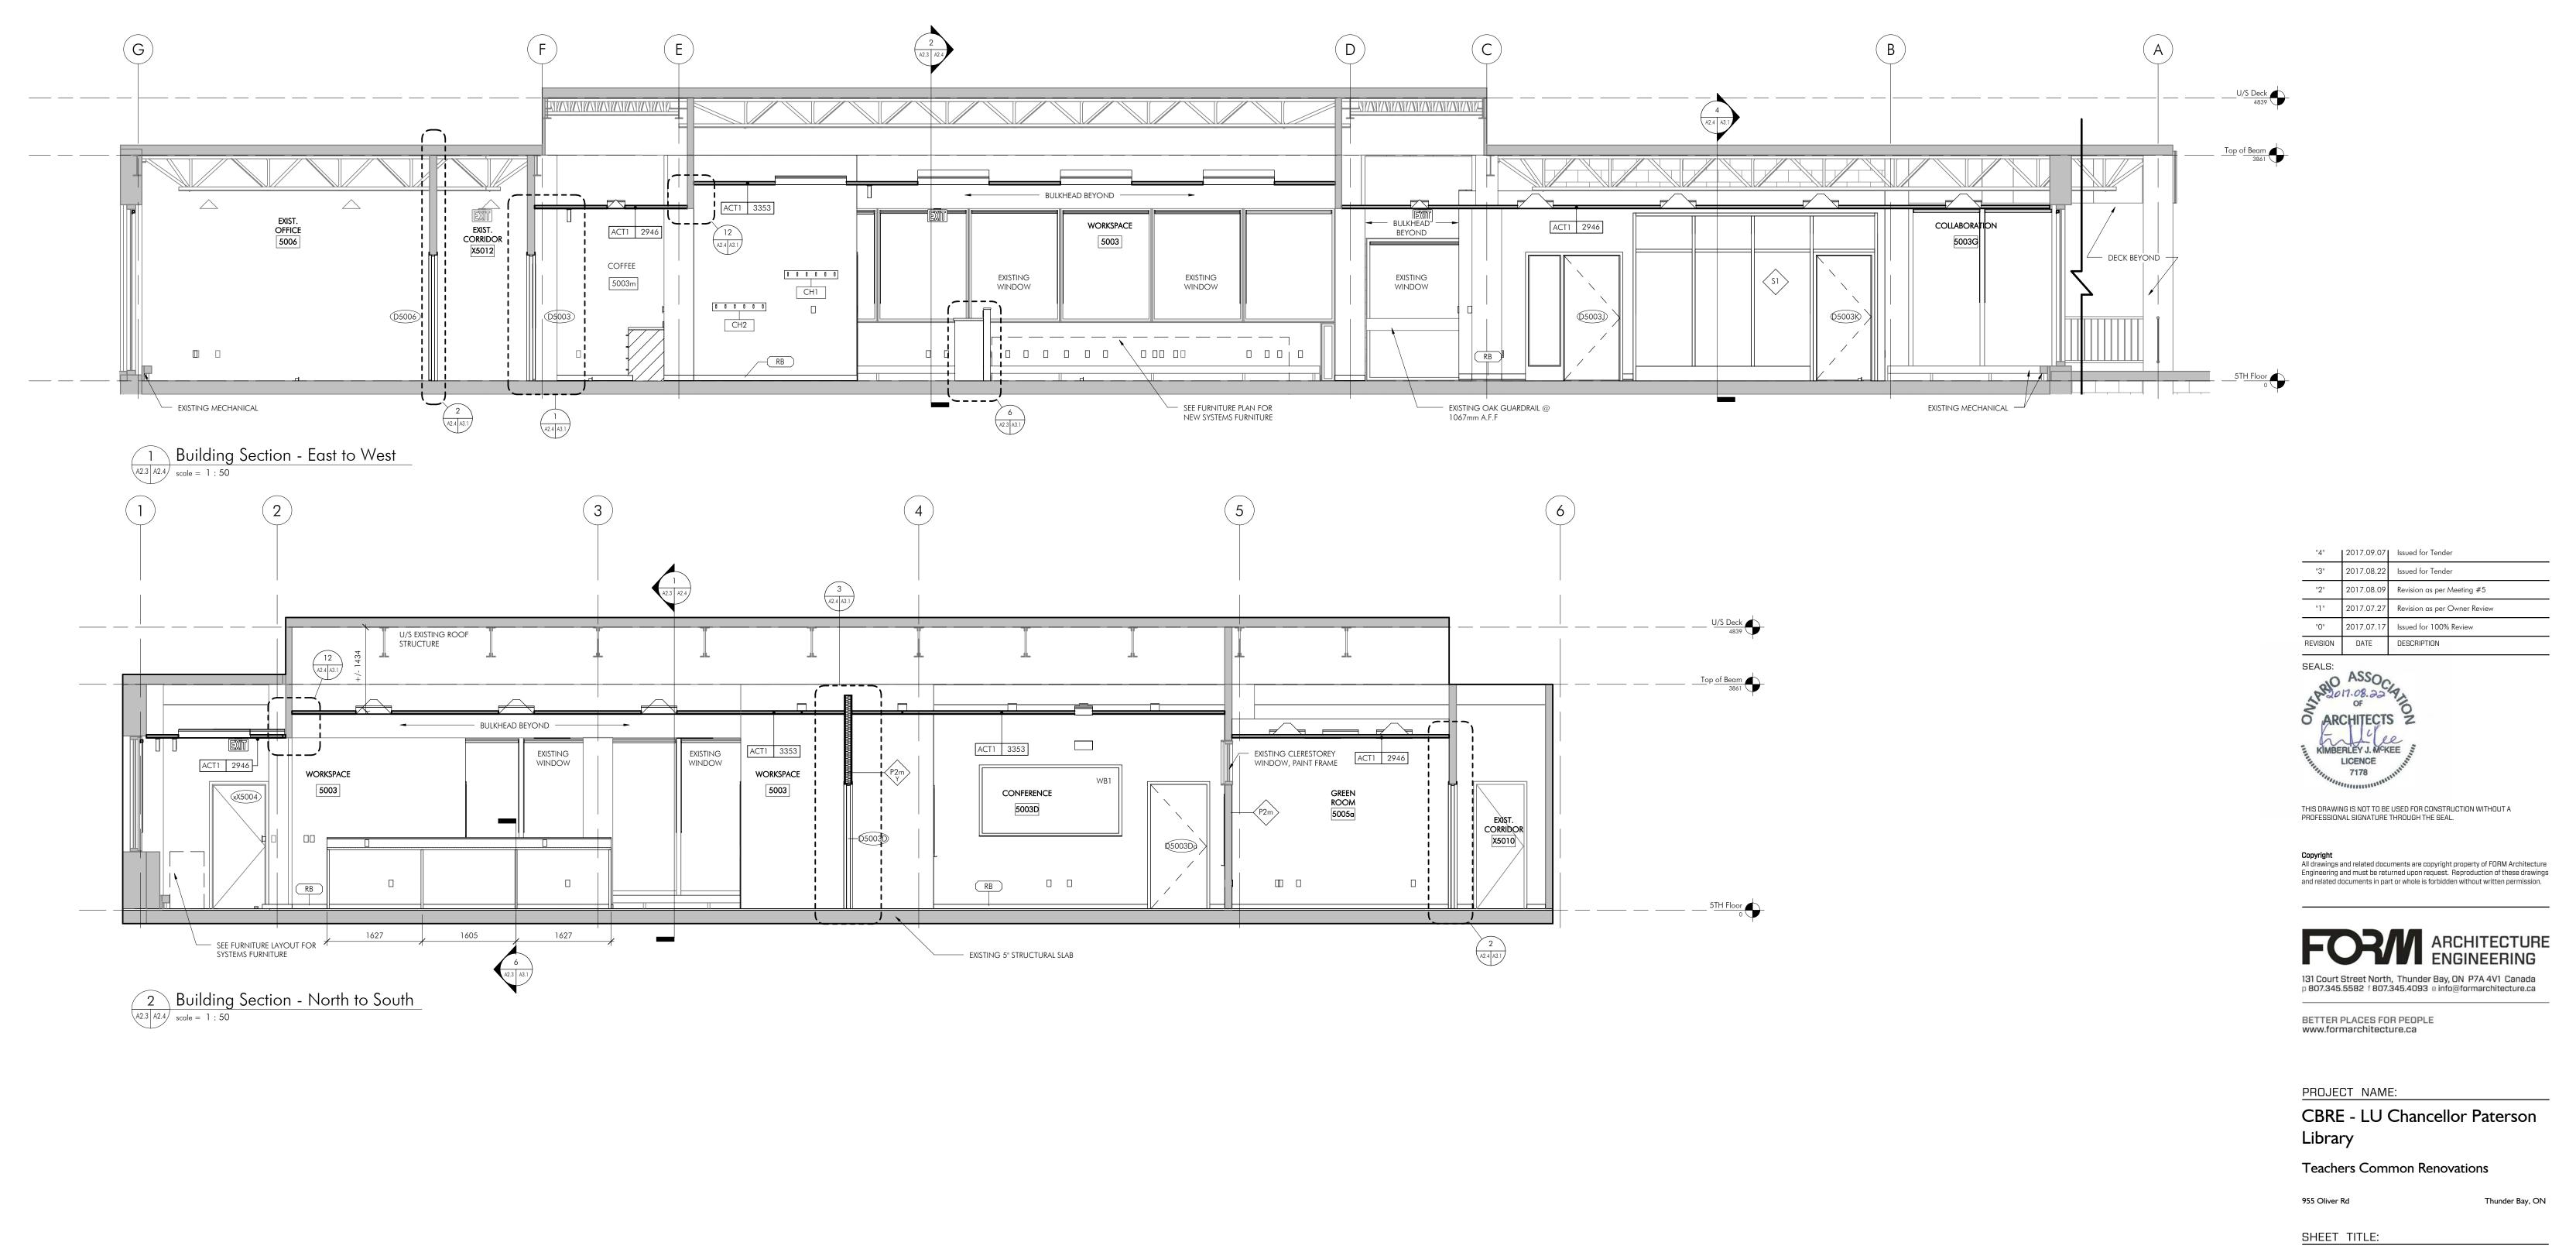
SHEET TITLE:

Renovation Floor Plan, Reflected Ceiling Plan

PROJECT:	2017024
DRAWN:	SLP/SRP
DATE:	August 2017

A2.3





DATE:	August 2017
DRAWN:	SLP
PROJECT:	2017024

Renovation Building Sections

A2.4



"4" | 2017.09.07 | Issued for Tender

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CBRE - LU Chancellor Paterson

Thunder Bay, ON

Teachers Common Renovations

Wall Sections, Plan & Section

Revision as per Owner Review

Issued for 100% Review

"3" 2017.08.22

REVISION DATE

ASSOCIATION OF

KIMBERLEY J. MCKEE

LICENCE 7178

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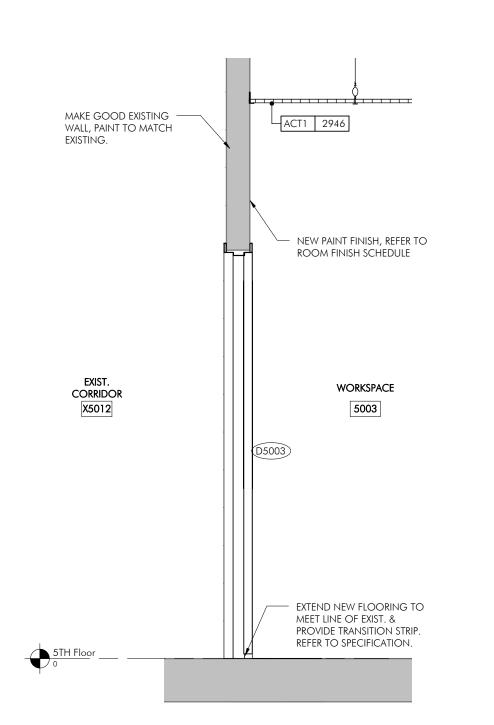
955 Oliver Rd

Details


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SHEET TITLE:

SEALS:






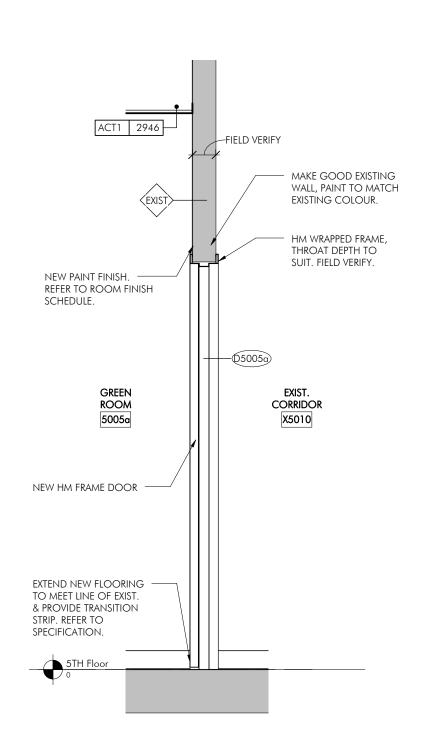


2 Wall Section - New Door @ Existing Wall A2.4 A3.1 scale = 1 : 20

- SYSTEMS FURNITURE,


SEE SHEET A7.1

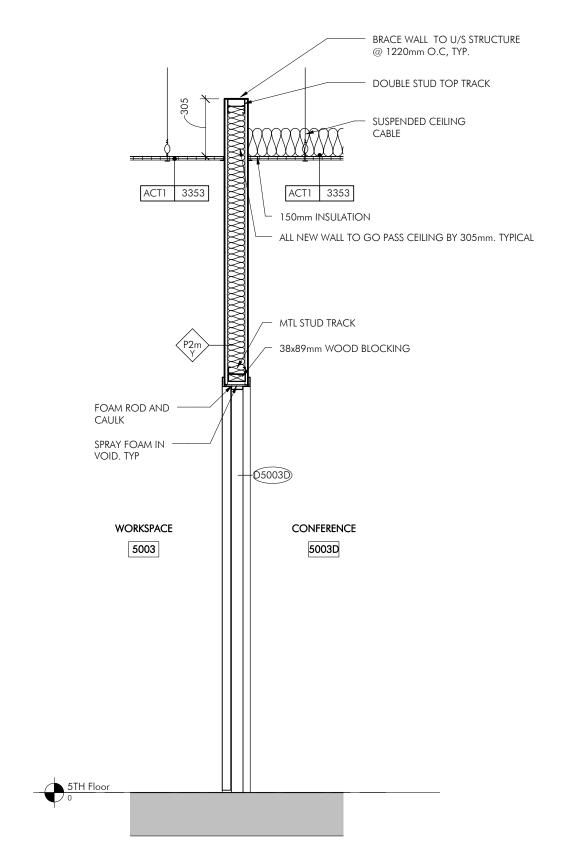


(3) Wall Section - Door @ Conference (A2.4) (A3.1) (A3.1)

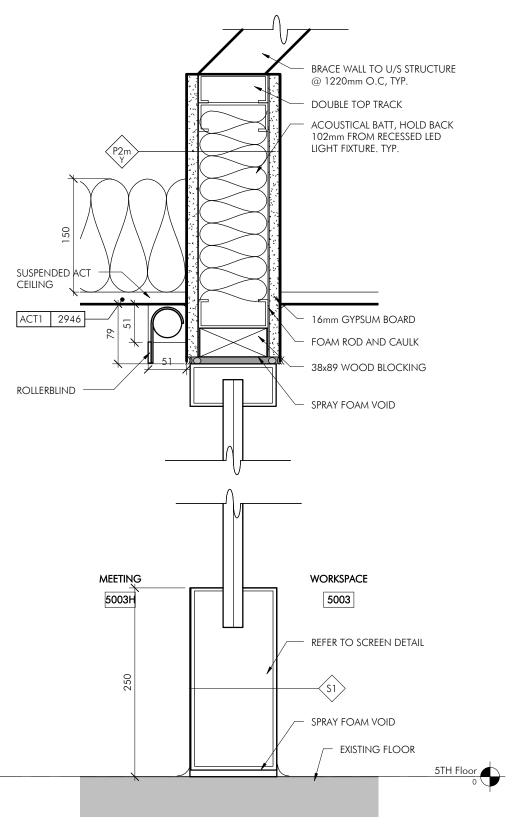

4 Section Detail - Hollow Metal Screen S1 A2.4 A3.1 scale = 1 : 5

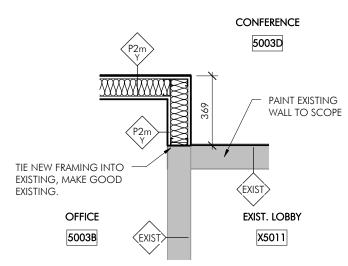



11 Plan Detail - New Walls @ Existing Corner

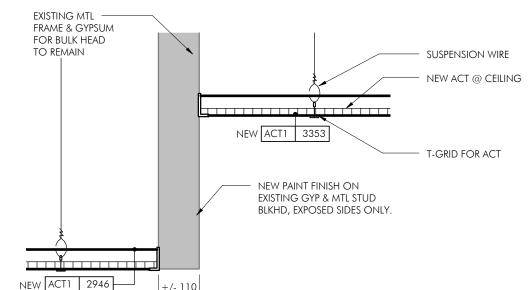


Section Detail - Ceiling Bulkhead

A2.4 A3.1 scale = 1:10

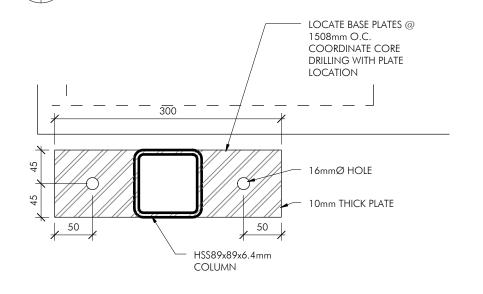


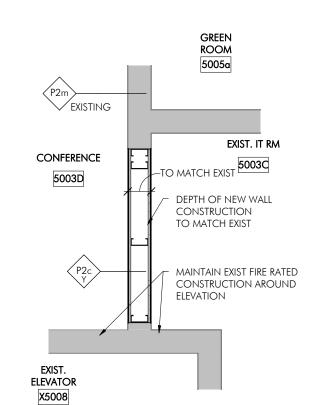


9 Plan Detail - Infilled Wall @ Demo Door A3.1 scale = 1 : 20

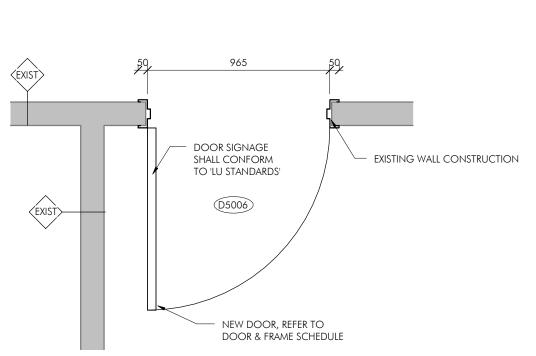


10 Plan Detail - New Door in Existing - Typical A3.1 scale = 1 : 20

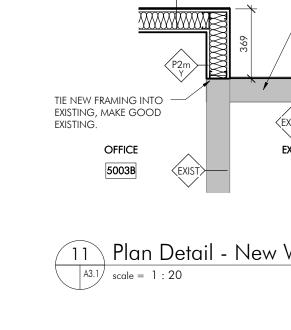

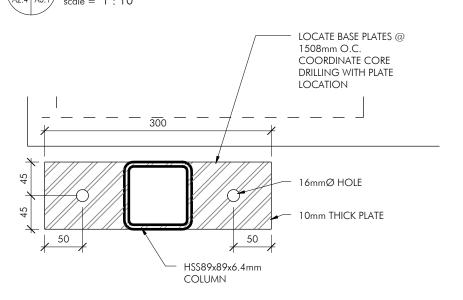

13 HSS89x89X6.4 Base PLate A3.1 scale = 1 : 5

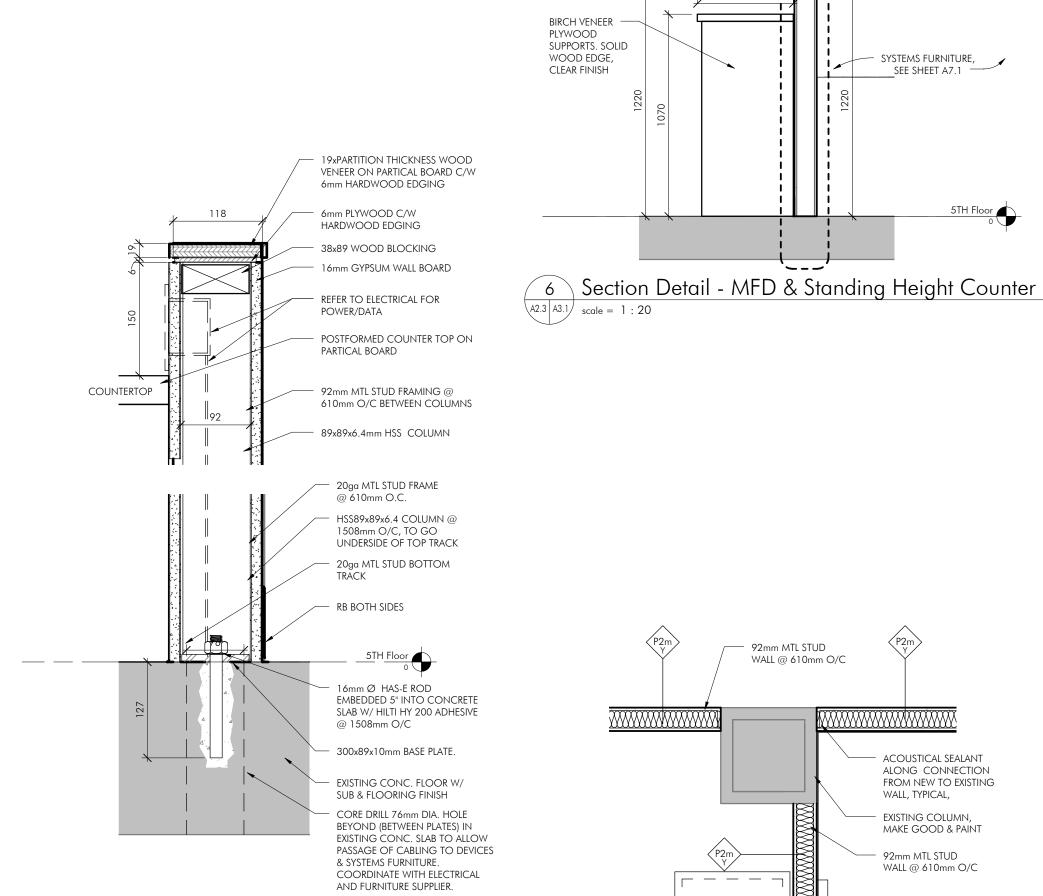

92mm MTL STUD WALL @ 610mm O/C - ACOUSTICAL SEALANT ALONG CONNECTION FROM NEW TO EXISTING WALL, TYPICAL, - EXISTING COLUMN, MAKE GOOD & PAINT 92mm MTL STUD WALL @ 610mm O/C

7 Plan Detail - New Walls @ Existing Column A3.1 scale = 1 : 20



FURR OUT

RESIDUAL AREA

- PATCH & MAKE

GOOD EXIST WALL

FINISH TO MATCH


COMMUNITY TACK

EXIST. LOBBY

X5011

NOTE: ALL PAINT FINISH COLOUR IN CORRIDORS TO MATCH

EXISTING, TYPICAL

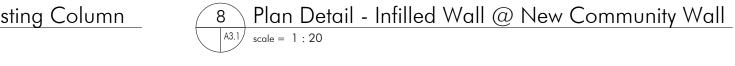

EXIST. CORRIDOR X5012

EXISTING COLUMN. ——

MAKE GOOD, PAINT

MTL STUD FRAMING

STUDS @ 610mm O/C

TIE IN NEW FRAMED WALL ----


MAKE GOOD WALL, PAINT_-

TENANT SIDE TO SCOPE

INTO EXISTING FRAME

OFFICE

5003A

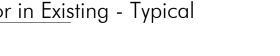


5 Section Detail - Wall Cap

| Section Detail - Wall Cap | Section Detail - Wall Cap |


PROJECT: 2017024


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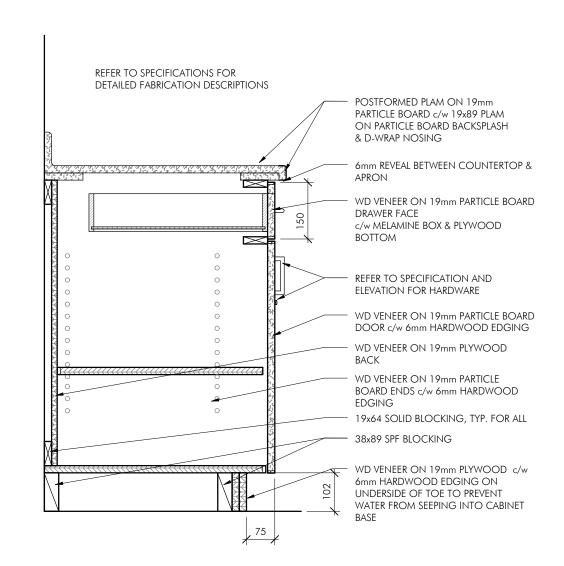


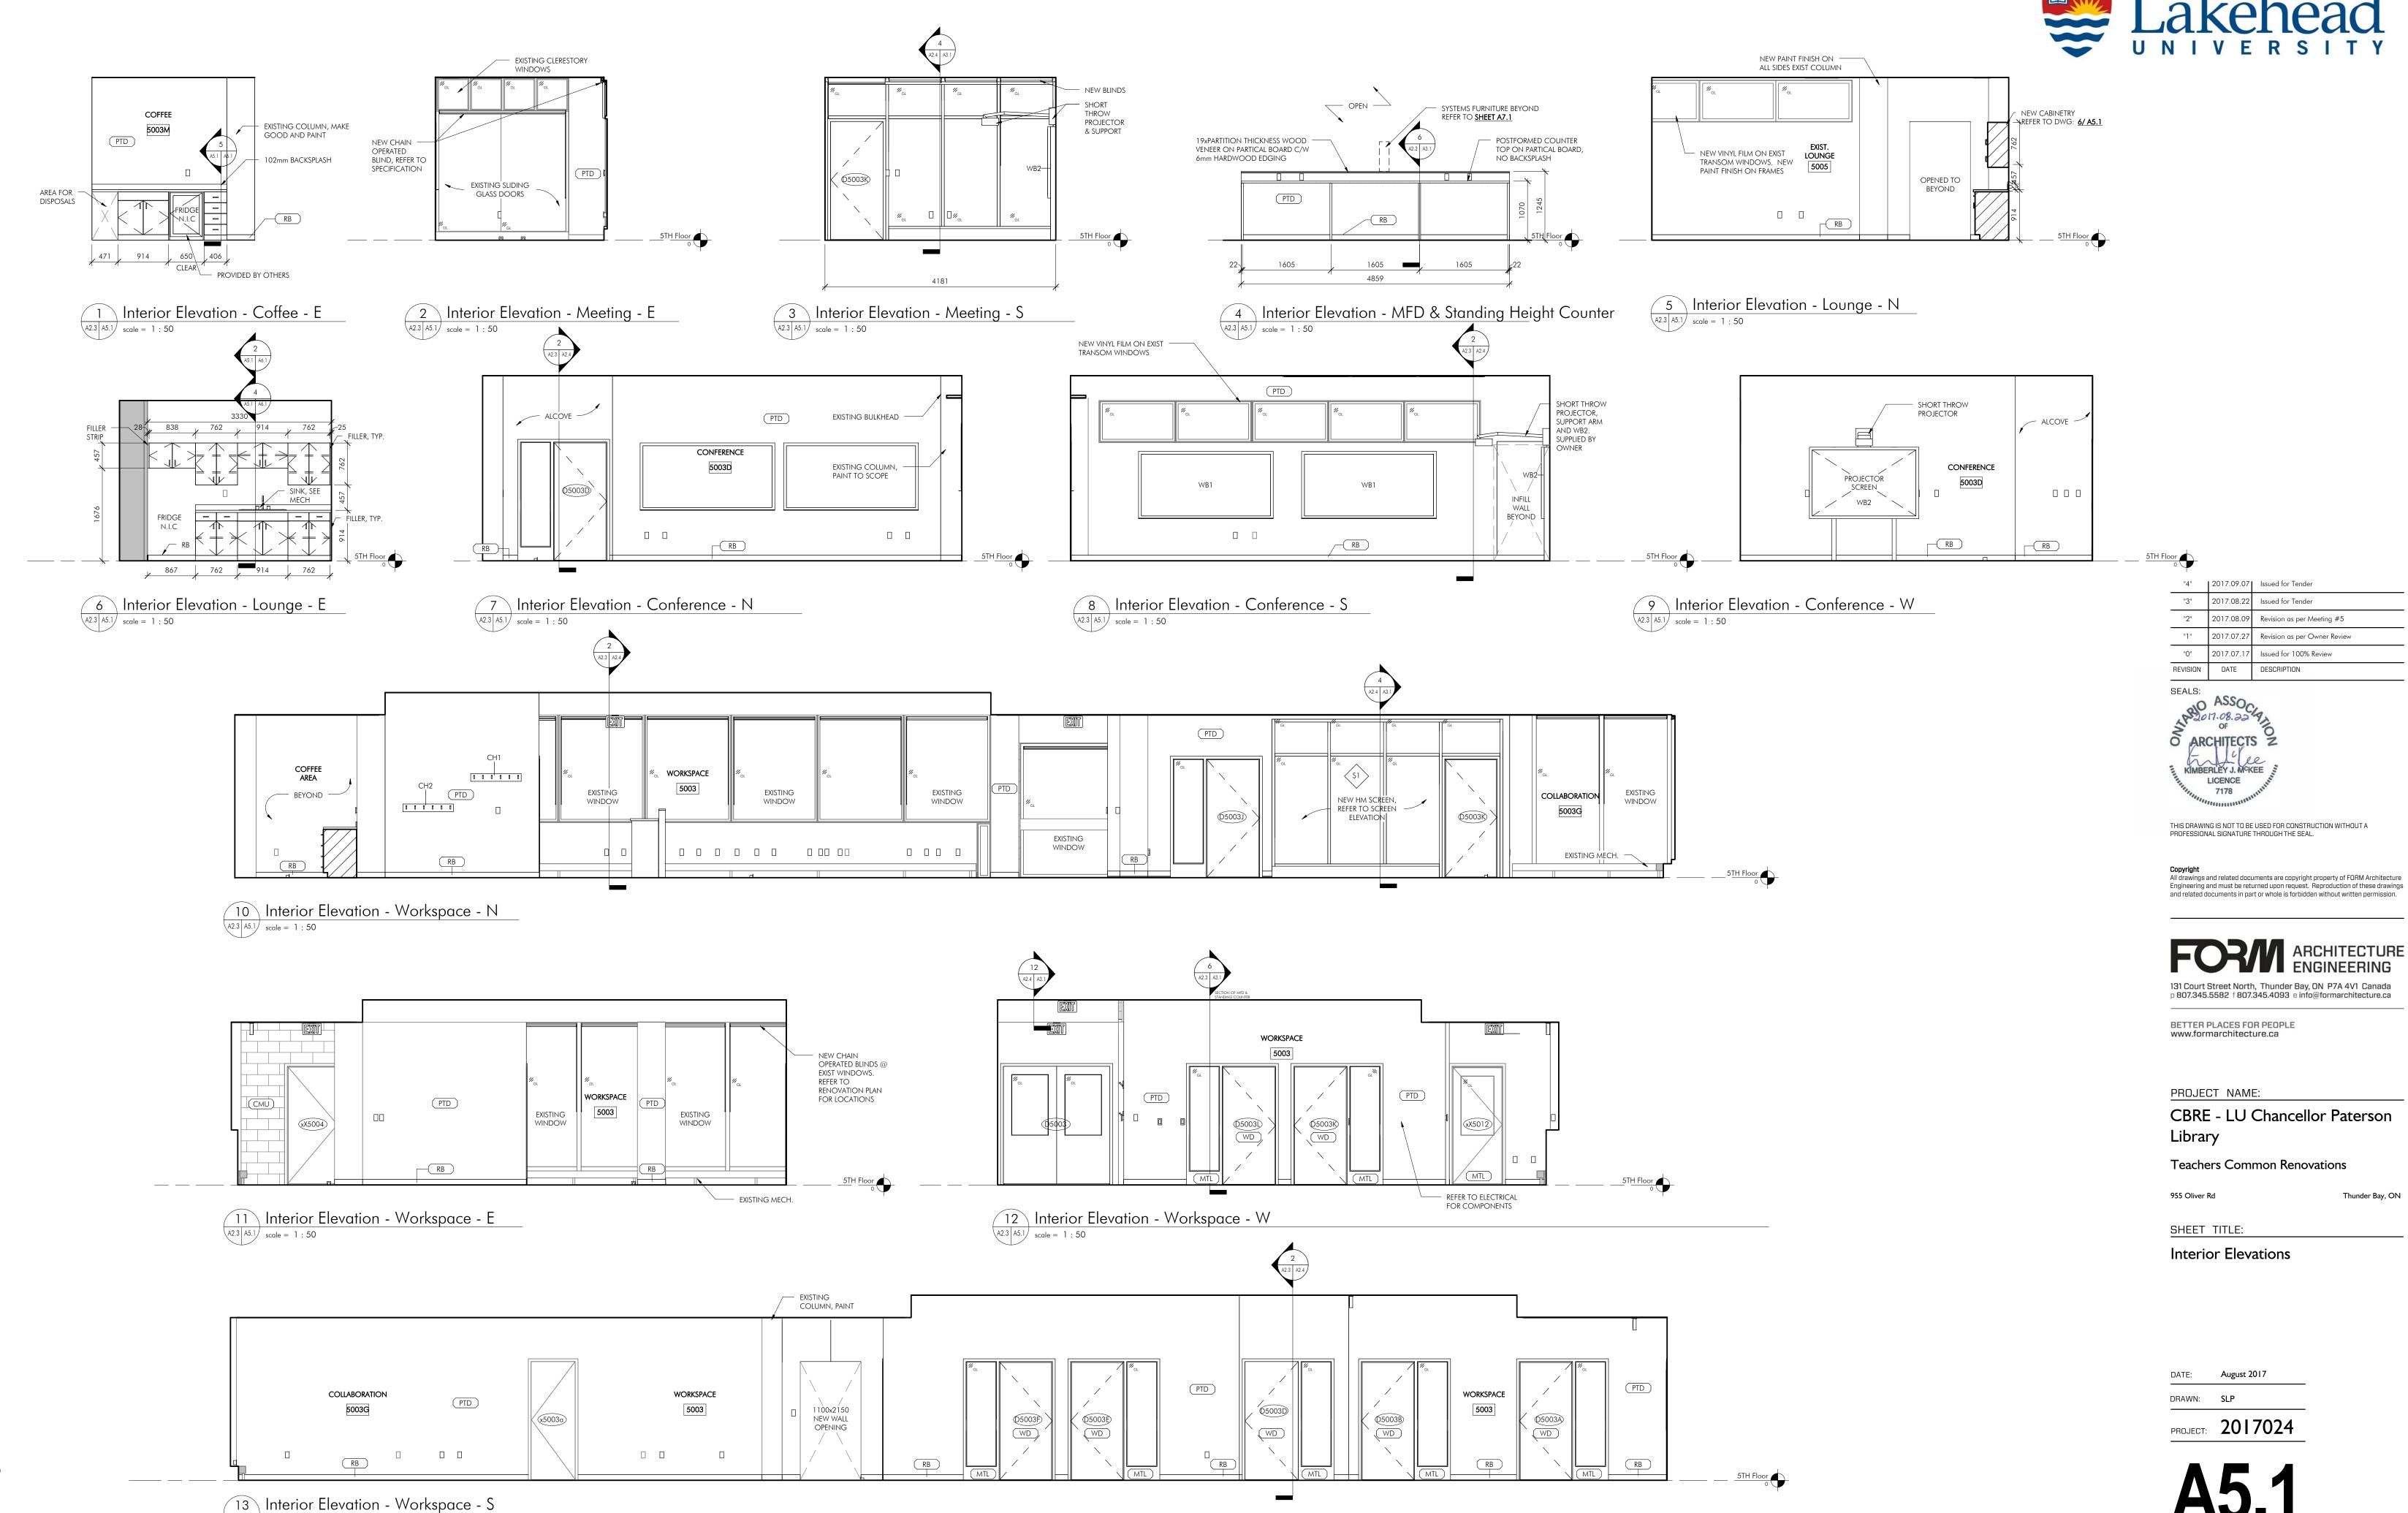A2.3 A5.1 scale = 1:50






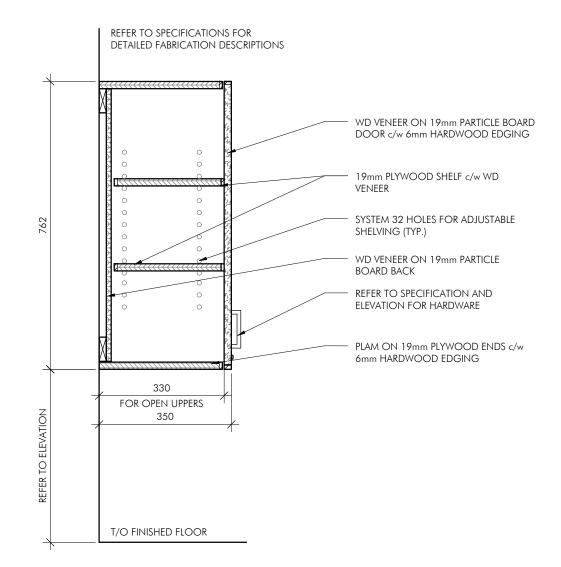

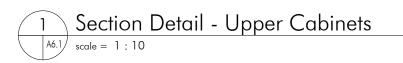


Section Detail - Base w/ Top Drawer

A6.1) scale = 1:10

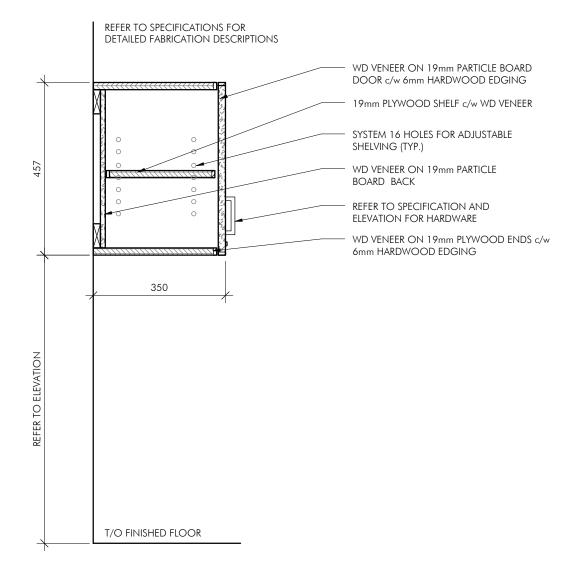


Section Detail - Upper Cabinets Over Sink/Fridge

A5.1 A6.1 scale = 1:10

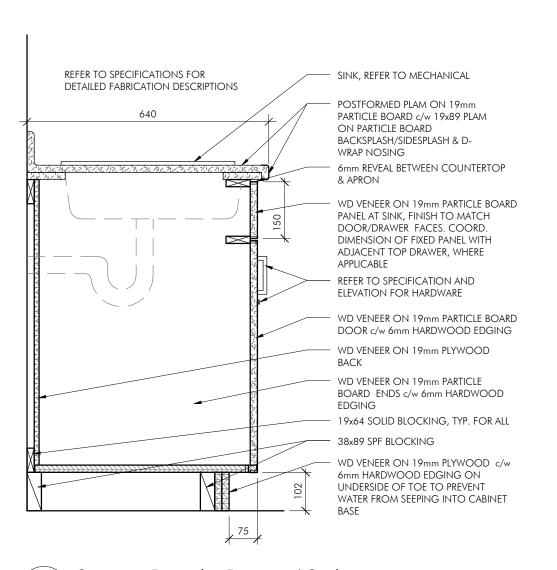

Section Detail - Base w/ Sink


A5.1 A6.1 scale = 1:10

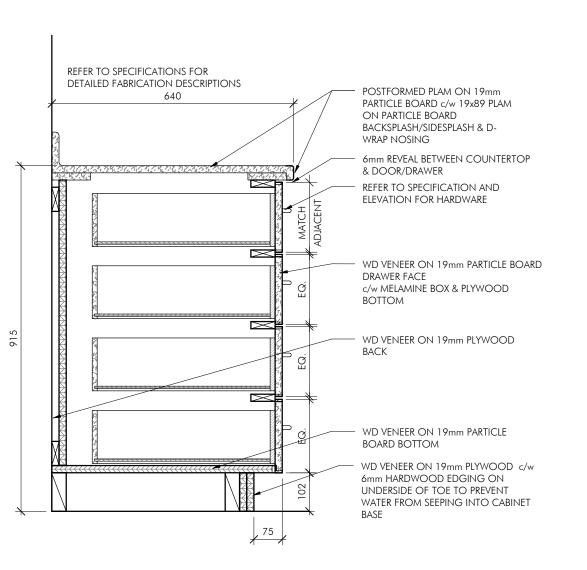

5 Section Detail - Base w/ Four Drawers

A5.1 A6.1 scale = 1:10

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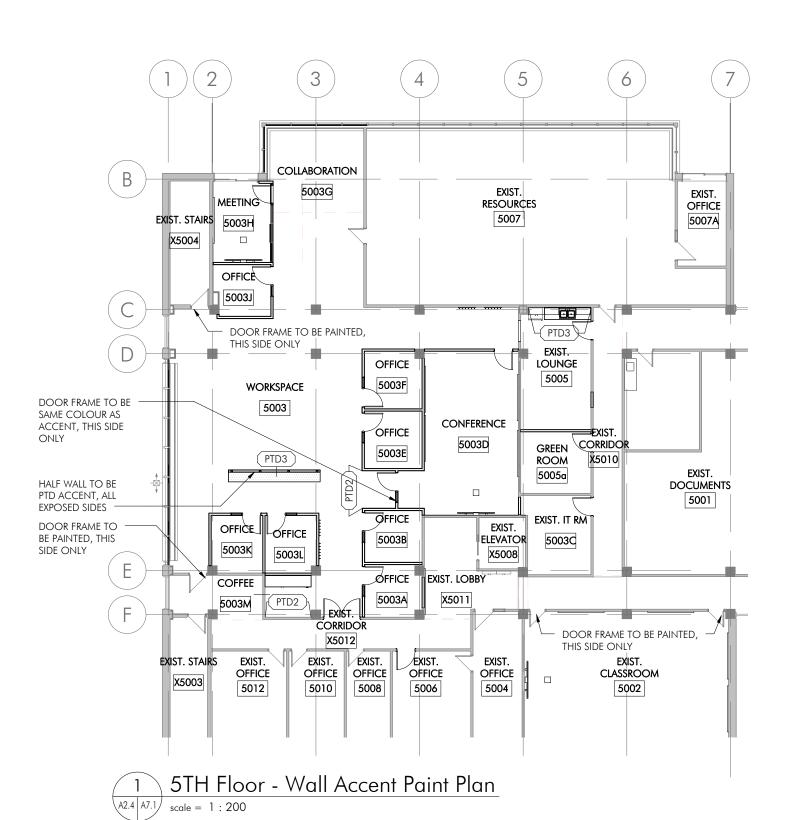
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SHEET TITLE:

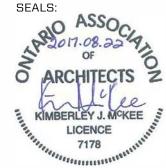Millwork Details

DRAWN:	SLP
PROJECT:	2017024



FINISH LEGEND

- PTD1 SHERWIN WILLIAMS, SW 7551, GREEK VILLA,
 ALL WALLS, CEILINGS HM SCREENS, FRAMES AND DOORS TO BE
 PTD1 UNLESS NOTED OTHERWISE ON ACCENT PLAN
- PTD2 SHERWIN WILLIAMS, SW 6552, DEWBERRY
- PTD3 SHERWIN WILLIAMS, SW 6811, HONORABLE BLUE


 REFER TO SPECIFICATION FOR SPECIFIC PRODUCTS, COLOURS
 NOTED BELOW.
- LVT1 INTERFACE FLOOR, LEVEL SET, LVT, A00203, CHESTNUT
- TR/RB JOHNSONITE, FAWN, 80
- CPT1 INTERFACE FLOOR, HUMAN CONNECTIONS, PROGRESSION SERIES III, DESERT SHADOW & FAWN, MIXED 55%/45%
- PLAM1 FORMICA, NEUTRAL TWILL, 8826-58 ALL COUNTER TOPS.

FINISH NOTES

- WHERE ACOUSTIC DOOR IS USED (REFER TO SPECIFICATION AND DOOR SCHEDULE), USE FLAT THRESHOLD TRANSITION FOR DOOR SWEEP TO SIT TIGHTLY ON, EVEN WHERE SIMILAR FLOORS
- 2. ALL FLOORING TRANSITIONS TO OCCUR AT CENTERLINE OF DOOR.
- USE TRANSITION AT ALL DISIMILAR FLOORING, EXCLUDING TRANSITION BETWEEN LVT AND NEW CPT (USE TRANSITION AT EXIST CPT).
- ALL FLOORING TO BE INSTALLED IN HERRINGBONE PATTERN 45DEGREES TO ADJACENT WALLS (V-INSTALLATION, NOT L-INSTALLATION).

FURNITURE NOTES


- READ FURNITURE SCHEDULE IN CONJUNCTION WITH ELECTRICAL DRAWINGS AND SPECIFICATION.
- 2. COORDINATE CORE DRILLING & FLOOR BOX LOCATION WITH ELECTRICAL AND FURNITURE SUPPLIER
- 3. FIELD VERIFY ALL DIMENSIONS PRIOR TO PLACING AN ORDER
- **4.** THE FURNITURE SUPPLIER IS RESPONSIBLE FOR VERIFYING THAT THE PRODUCTS SPECIFIED ARE COMPATIBLE WITH EACH OTHER.
- 5. REQUEST FOR EQUAL SUBMISSIONS ARE TO BE:
 BASED ON CONSTRUCTION AND QUALITY OF GLOBAL
 FURNITURE GROUP SERIES NOTED IN SCHEDULE, EQUAL TO
 OR BETTER.
 TAGGED WITH FURNITURE TAG PROVIDED IN DRAWINGS.
 CUT-SHEETS/BROCHURES TO BE HIGHLIGHTED TO SHOW
 HOW IT IS EQUAL WITH IMAGE OF EACH PIECE.
 MUST MEET SIZE REQUIREMENTS SHOWN IN SCHEDULE,
 CHAIRS AND LOUNGE SEATING CAN BE 50mm LARGER,
 HEIGHTS OF SEAT BACKS CAN VARY.
 -SUBMIT IN ACCORDANCE WITH SPECIFICATION SECTION
 00 21 13 INSTRUCTIONS TO BIDDERS.
- 6. QUANTITIES ARE TO COME FROM THE PLANS, NOT SCHEDULE. SCHEDULE INTENDED FOR VERIFYING. CONTACT PROJECT CONSULTANT IF THERE ARE DISCREPANCIES.
- 7. FABRICS TO BE TWO ABOVE LOWEST GRADE.
- 8. VINYL TO BE 100% VINYL or ENVIRO LEATHER BY LDI (55-60% TPE, 26-35% POLYESTER, 10-14% COTTON), NO SUBSTITUTIONS.
- UP TO TWO LAMINATE COLOURS PER WORKSTATION (WOOD LOOK TOP, SOLID BASE/STORAGE)
- 10. ALL HARDWARE TO BE SILVER SQUARE EDGE HANDLE/SMALL HANDLE
- 11. FURNITURE TO HAVE "METAL TO METAL" CONNECTIONS AS MINIMUM
- 12. COORDINATE GROMMET LOCATIONS WITH OWNER/ LUTSC

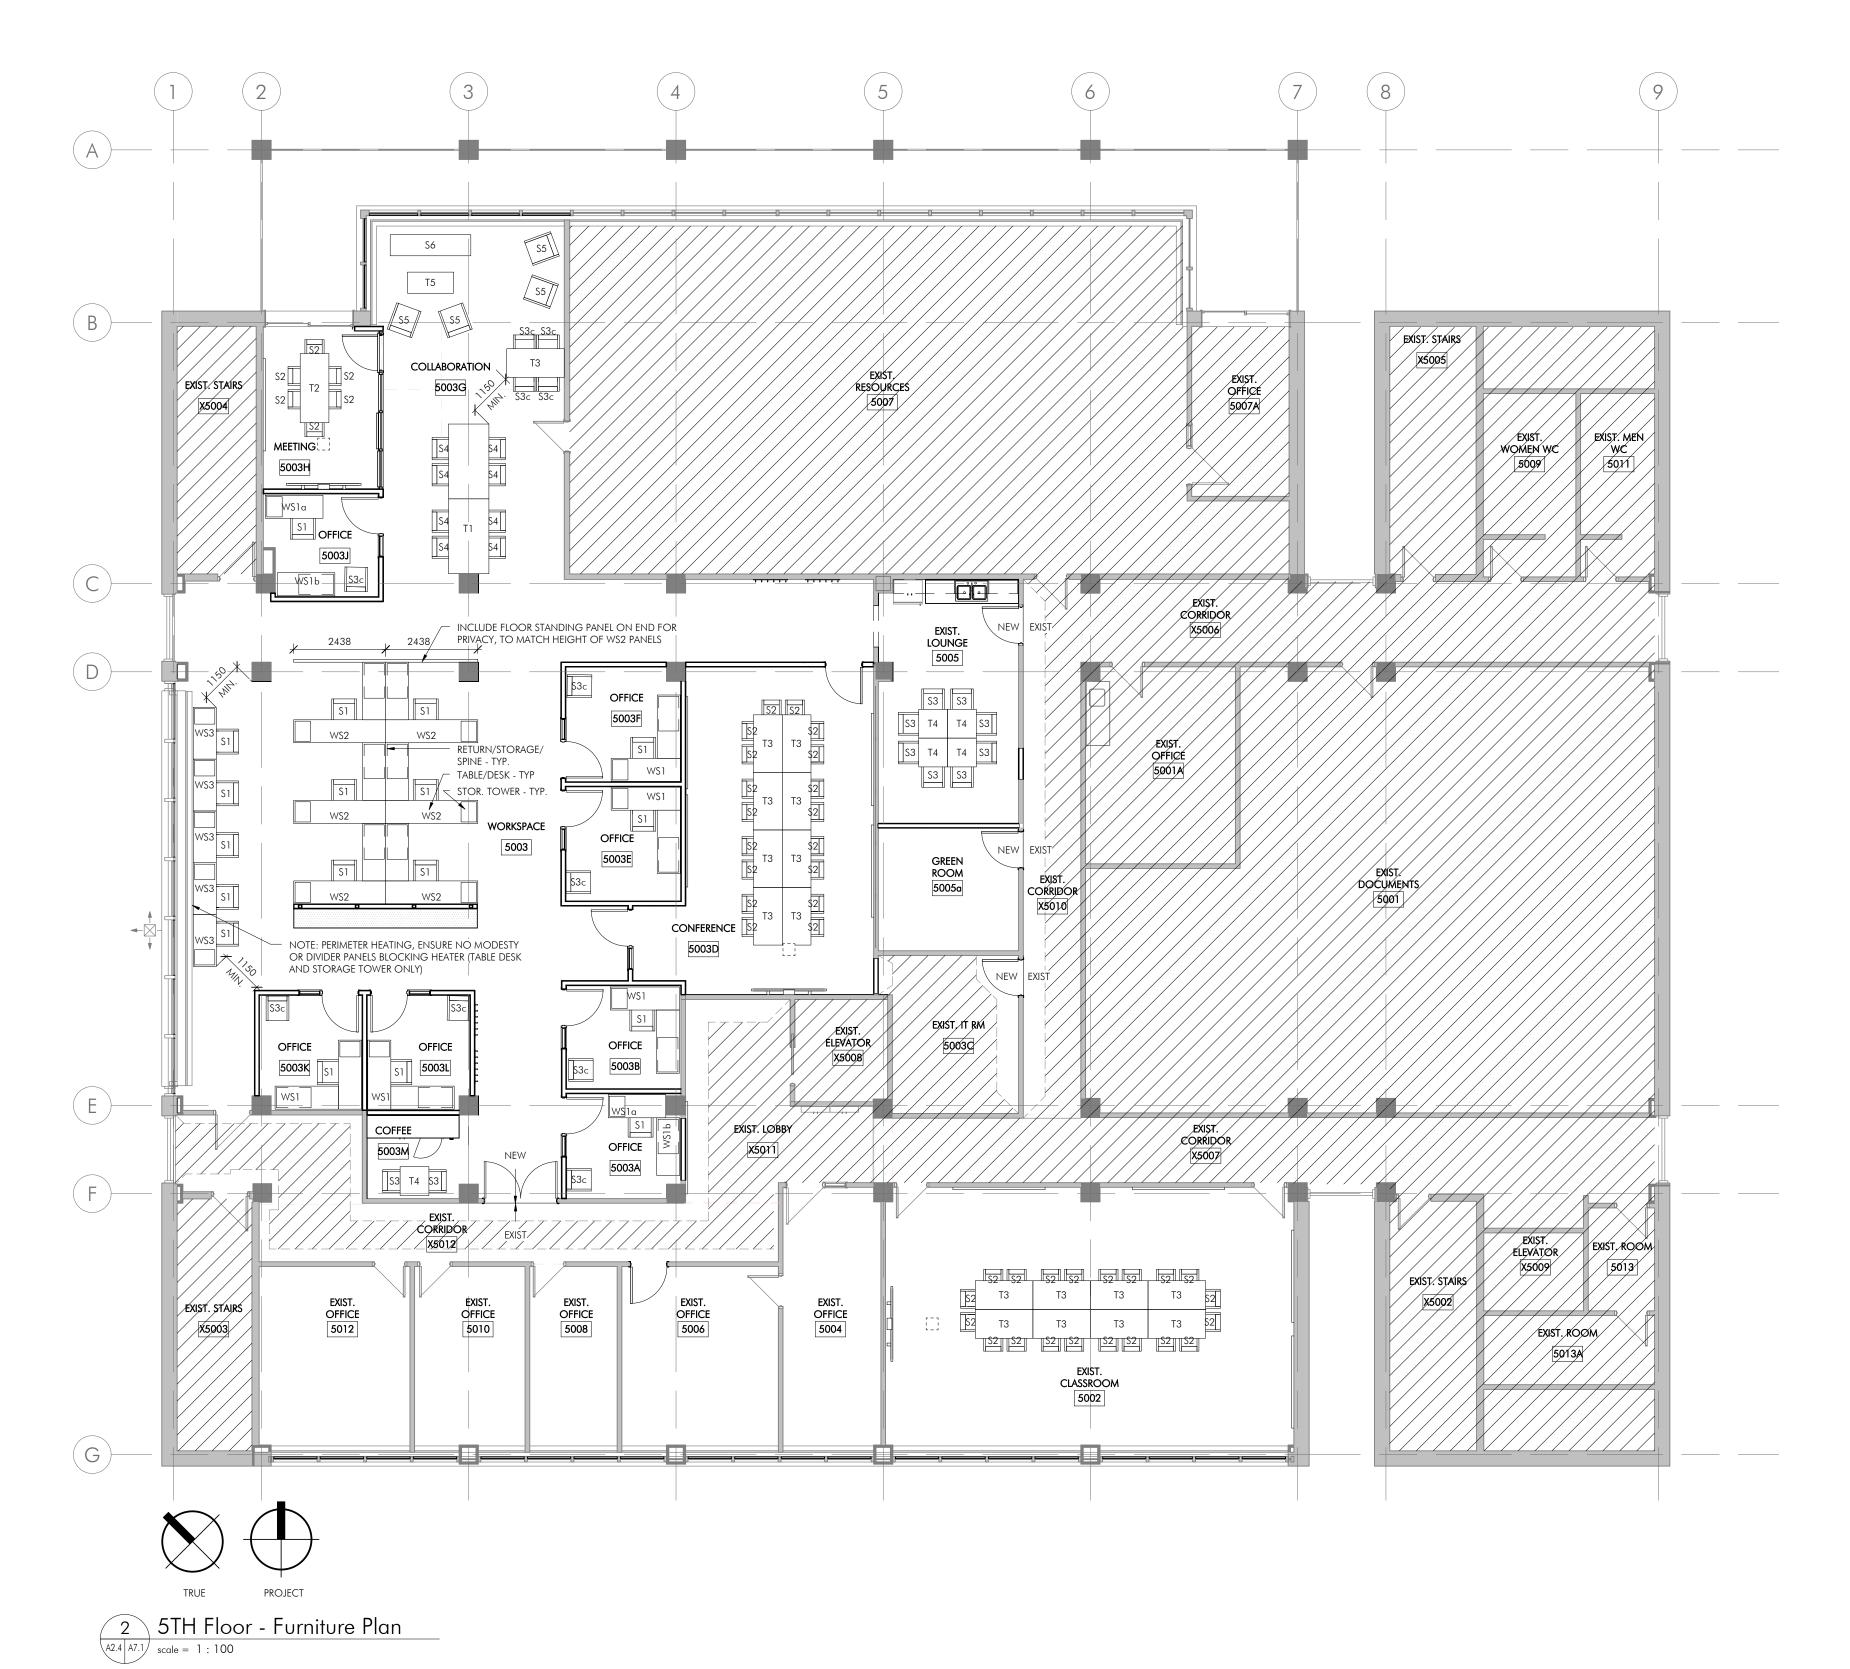

Furniture Schedule									
Tag	Туре	Based on Global Furniture Group, Series (Similar to, Alternates Welcome)	Width	n Denth	Height	Materials	Furniture Description	Accessories	Qty.
	3361B	Global Furniture Group	Widii	Depin	rieigiii	Wind & Wind Linear - Bench & Ottoman	1 offiliore Description	7 (CCessories	Giy.
	Office - Task Chair w/Arms - Fab	Vion	660	635	1118	fabric, urethane, metal, mesh	mid-back, mesh back, seat depth adjustability, adjustable arms, rated for 300lb capacity, adjustable lumbar, frame finish required to be white or grey (black only is not acceptable alternate).	carpet casters	18
	Office - Arm Chair Nesting w/Casters - Fab	Spritz	508	559	889	fabric, mesh, metal	nesting, mesh back, frame finish required to be white or grey (black only is not acceptable alternate).	carpet casters	44
	Office - Armless Chair w/ Casters LVT	Lite	603	648	870	fabric, metal	hard surface casters, frame finish required to be white or grey (black only is not acceptable alternate).	carpet casters	10
	Office - Armless Chair w/ Casters - CPT	Lite	603	648	870	fabric, metal	carpet casters, frame finish required to be white or grey (black only is not acceptable alternate).	carpet casters	11
	Office - Arm Chair w Casters - Bistro HT	APP mid back stool	591	635	1016	LAM wood veneer, single shell & back	ensure compatible with special island, frame finish required to be white or grey (black only is not acceptable alternate).	carpet casters	8
S5	Lounge - Arm Chair Fully Upholstered	Wind Linear armless	686	737	724	vinyl, metal	single seater armless, chrome tubular base, fixed cushions	glides for carpet	4
S6	wind linear bench 72"	Wind Linear	2134	559	381	fabric metal	fully upholstered, chrome, fixed cushion	glides for carpet	1
П	Office - Standing Island - 42x42x78	Contract Collaboration Tables	1981	1067	1067	HP laminate, pvc edge, metal	carpet glides, two tables permenantly ganged 38 thick top & gables, ensure compatible with bistro chairs	foot rest, wire chase, include hat channel/support for length, carpet glides, power- two table top mount outlets (fed from whip, see elect)	2
T2	Office - Meeting Table - 30x72	Licence meeting table	1829	762	737	HP laminate, pvc edge, metal	powered pedestal, power / data block at desk surface	rectangular base, power module	1
T3	Office - Meeting Table - 30x60	Bungee Spider Leg Flip Top	1524	762	737	HP laminate, pvc edge, metal	nesting, max 150mm thick when neste	include hat channel/support for length, gang hardware, carpet casters	17
Γ4	Office - Bistro Table - 30x30	Contract Tables	762	762	737	HP laminate, pvc edge, metal	hard surface glides legs similar to monoleg	include hat channel/support for length, non-marking glides	5
5	Lounge - Coffee Table - 56x22	Wind Linear	1219	559	381	HP laminate, metal	-	glides for carpet	1
'S1	Desk - Shell 72x90 w/ Return, Ped & Storage Shell	Zira	1829	2286		HP laminate, matching pvc edge	L/R, see plan. Apply 3/4 modesty panel where desk shell/return runs along wall. 610D worksurfaces, 735H, 38T top. 380W Box Box File Ped.1070L Box File Open Storage Return	2 grommets, 2 wire chases, see description for main components	5
Sla	Desk - Shell 60	Zira	1524	2438		HP laminate, matching pvc edge	L/R, see plan. Apply 3/4 modesty panel where desk shell/return runs along wall. 610D worksurfaces, 735H, 38T top. 380W Box File Ped.	grommet, wire chase, see description for main components	2
S1b	Desk - Shell Return 60	Zira	1524	2134		HP laminate, matching pvc edge	L/R, see plan. Apply 3/4 modesty panel where desk shell/return runs along wall. 610D worksurfaces, 735H, 38T top.1070L Box File Open Storage Return	grommet, wire chase, see description for main components	2
VS2	Benching - Table 84x96 w/ Return, Storage Shell, Tower & Dividers	Bridges II	2438	2134		HP laminate, pvc edge, fabric panel divider, metal	L/R, see plan. 610D worksurfaces, 735H, 38T top. Rectandular leg Single Table c/w Viceversa Fabric Table Hung Divider, 610H above desk, modesty below desk, full length of table desk. 735H, 1070L Box File Open Storage Return c/w central fabric panel spine to match table divider height (include filler pieces as required). 1270H, 400W, Table D, Storage Tower c/w box file drawer with open storage at side and adjustable shelf.	2 grommets, 2 wire chases, power (fed from whip, see elect) outlets beneath desk, see description for main components	6
WS3	Benching - Table 54x24 w/Storage Tower	Bridges II	1372	1829		HP laminate, pvc edge, metal	610D worksurfaces, 735H, 38T top. Rectangular leg Single Table 735H, 1270H, 400W, Table D, Storage Tower c/w box file drawer with open storage at side and adjustable shelf.	grommet; wire chase; linear 45mm high, surface mounted fascia / pencil stop; see description for main components	5



"4"	2017.09.07	Issued for Tender
"3"	2017.08.22	Issued for Tender
"2"	2017.08.09	Revision as per Meeting #5
"]"	2017.07.27	Revision as per Owner Review
"0"	2017.07.17	Issued for 100% Review
REVISION	DATE	DESCRIPTION

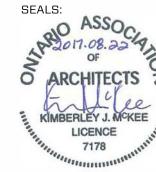

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PROJECT NAME:

CBRE - LU Chancellor Paterson Library

Teachers Common Renovations

955 Oliver Rd

SHEET TITLE:

Finishes, Furniture Layout & Schedule

Thunder Bay, ON

DATE:	August 2017
DRAWN:	SRP 2017024
PROJECT:	2017024

A7.1



	DUCTWORK
\longrightarrow	SUPPLY AIR FLOW ARROW
- √→	RETURN/EXHAUST AIR FLOW ARROW
	SUPPLY/OUTSIDE AIR DUCT UP
	SUPPLY/OUTSIDE AIR DUCT DOWN
[] 0	RETURN AIR DUCT UP
[] 0	RETURN AIR DUCT DOWN
\triangleright	EXHAUST AIR DUCT UP
	EXHAUST AIR DUCT DOWN
	RECTANGULAR DUCT
	ROUND DUCT
	MITERED ELBOW - RECTANGULAR DUCT
	BEVELED THROAT ELBOW - RECTANGULAR DUCT
	45° RADIUS ELBOW - RECTANGUALR DUCT
	45° RADIUS ELBOW - ROUND DUCT
	90° RADIUS ELBOW - RECTANGULAR DUCT
	90° RADIUS ELBOW - ROUND DUCT
	FLEX DUCT
	TAKE OFF CONNECTION
	SPIN-ON CONNECTION
	EXTERNALLY INSULATED DUCTWORK
	INTERNALLY LINED DUCTWORK
	SQUARE TO ROUND DUCT TRANSITION
	TYP SQUARE DIFFUSER
BDD BDD	BACKDRAFT DAMPER
T	THERMOSTAT
SC	SPEED CONTROL

	<u>DRAWING LIST</u>	
DWG NO.	DRAWING NAME	
MO	MECHANCIAL LEGEND AND DRAWING LIST	
M2	HVAC DEMOLITION	
M4	HVAC RENOVATION	
M5	MECHANICAL SPECIFICATION	
M1	PLUMBING DEMOLITION	
M3	PLUMBING RENOVATION	

 ${\it NOTE}$: NOT ALL SYMBOLS SHOWN ON THIS LEGEND ARE NECESSARILY USED ON THIS PROJECT.

	1	
2	2017.08.21	Issued for Tender
1	2017.07.14	Issued for Client Review
REVISION	DATE	DESCRIPTION

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PROJECT NAME:

CBRE - LU Chancellor Paterson Library

Teachers Common Renovations

SHEET TITLE:

MECHANCIAL LEGEND AND DRAWING LIST

DATE: 07/13/17

DRAWN:

PROJECT: 11785

MO





PLUMBING DEMOLITION

GENERAL NOTES

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- 5. CONTRACTOR TO ENSURE ALL MATERIALS MODIFIED OR INSTALLED IN AN AIR PLENUM ARE RATED FOR SUCH
- 6. CONTRACTOR TO MAINTAIN DIGITAL PHOTOGRAPHIC RECORDS OF ALL INSTALLATIONS PRIOR TO CONCEALMENT BY SUPPORTING
- 7. MECHANICAL CONTRACTOR TO COORDINATE WITH GENERAL CONTRACTOR FOR SCANNING, CUTTING AND PATCHING OF FLOOR AND SLAB TO DETERMINE EXACT LOCATION OF EXISTING DRAIN PIPES WHERE NEW DRAIN PIPES TIE
- 8. PROVIDE CAP ON ALL PIPING TO PREVENT DEBRIS ENTERING SYSTEM.
 9. PROVIDE PROWRAP (TM) OR APPROVED EQUAL ON ALL EXPOSED PIPING UNDER BARRIER FREE LAVATORIES AND

DRAWING NOTES:

1) REMOVE EXISTING DOUBLE COMPARTMENT SINK. TEMPORARILY CAP THE DOMESTIC HOT AND COLD WATER PIPING AND SANITARY DRAINAGE FOR RE-ROUTE TO NEW SINK LOCATION.

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PROJECT NAME:

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Teachers Common Renovations

SHEET TITLE:

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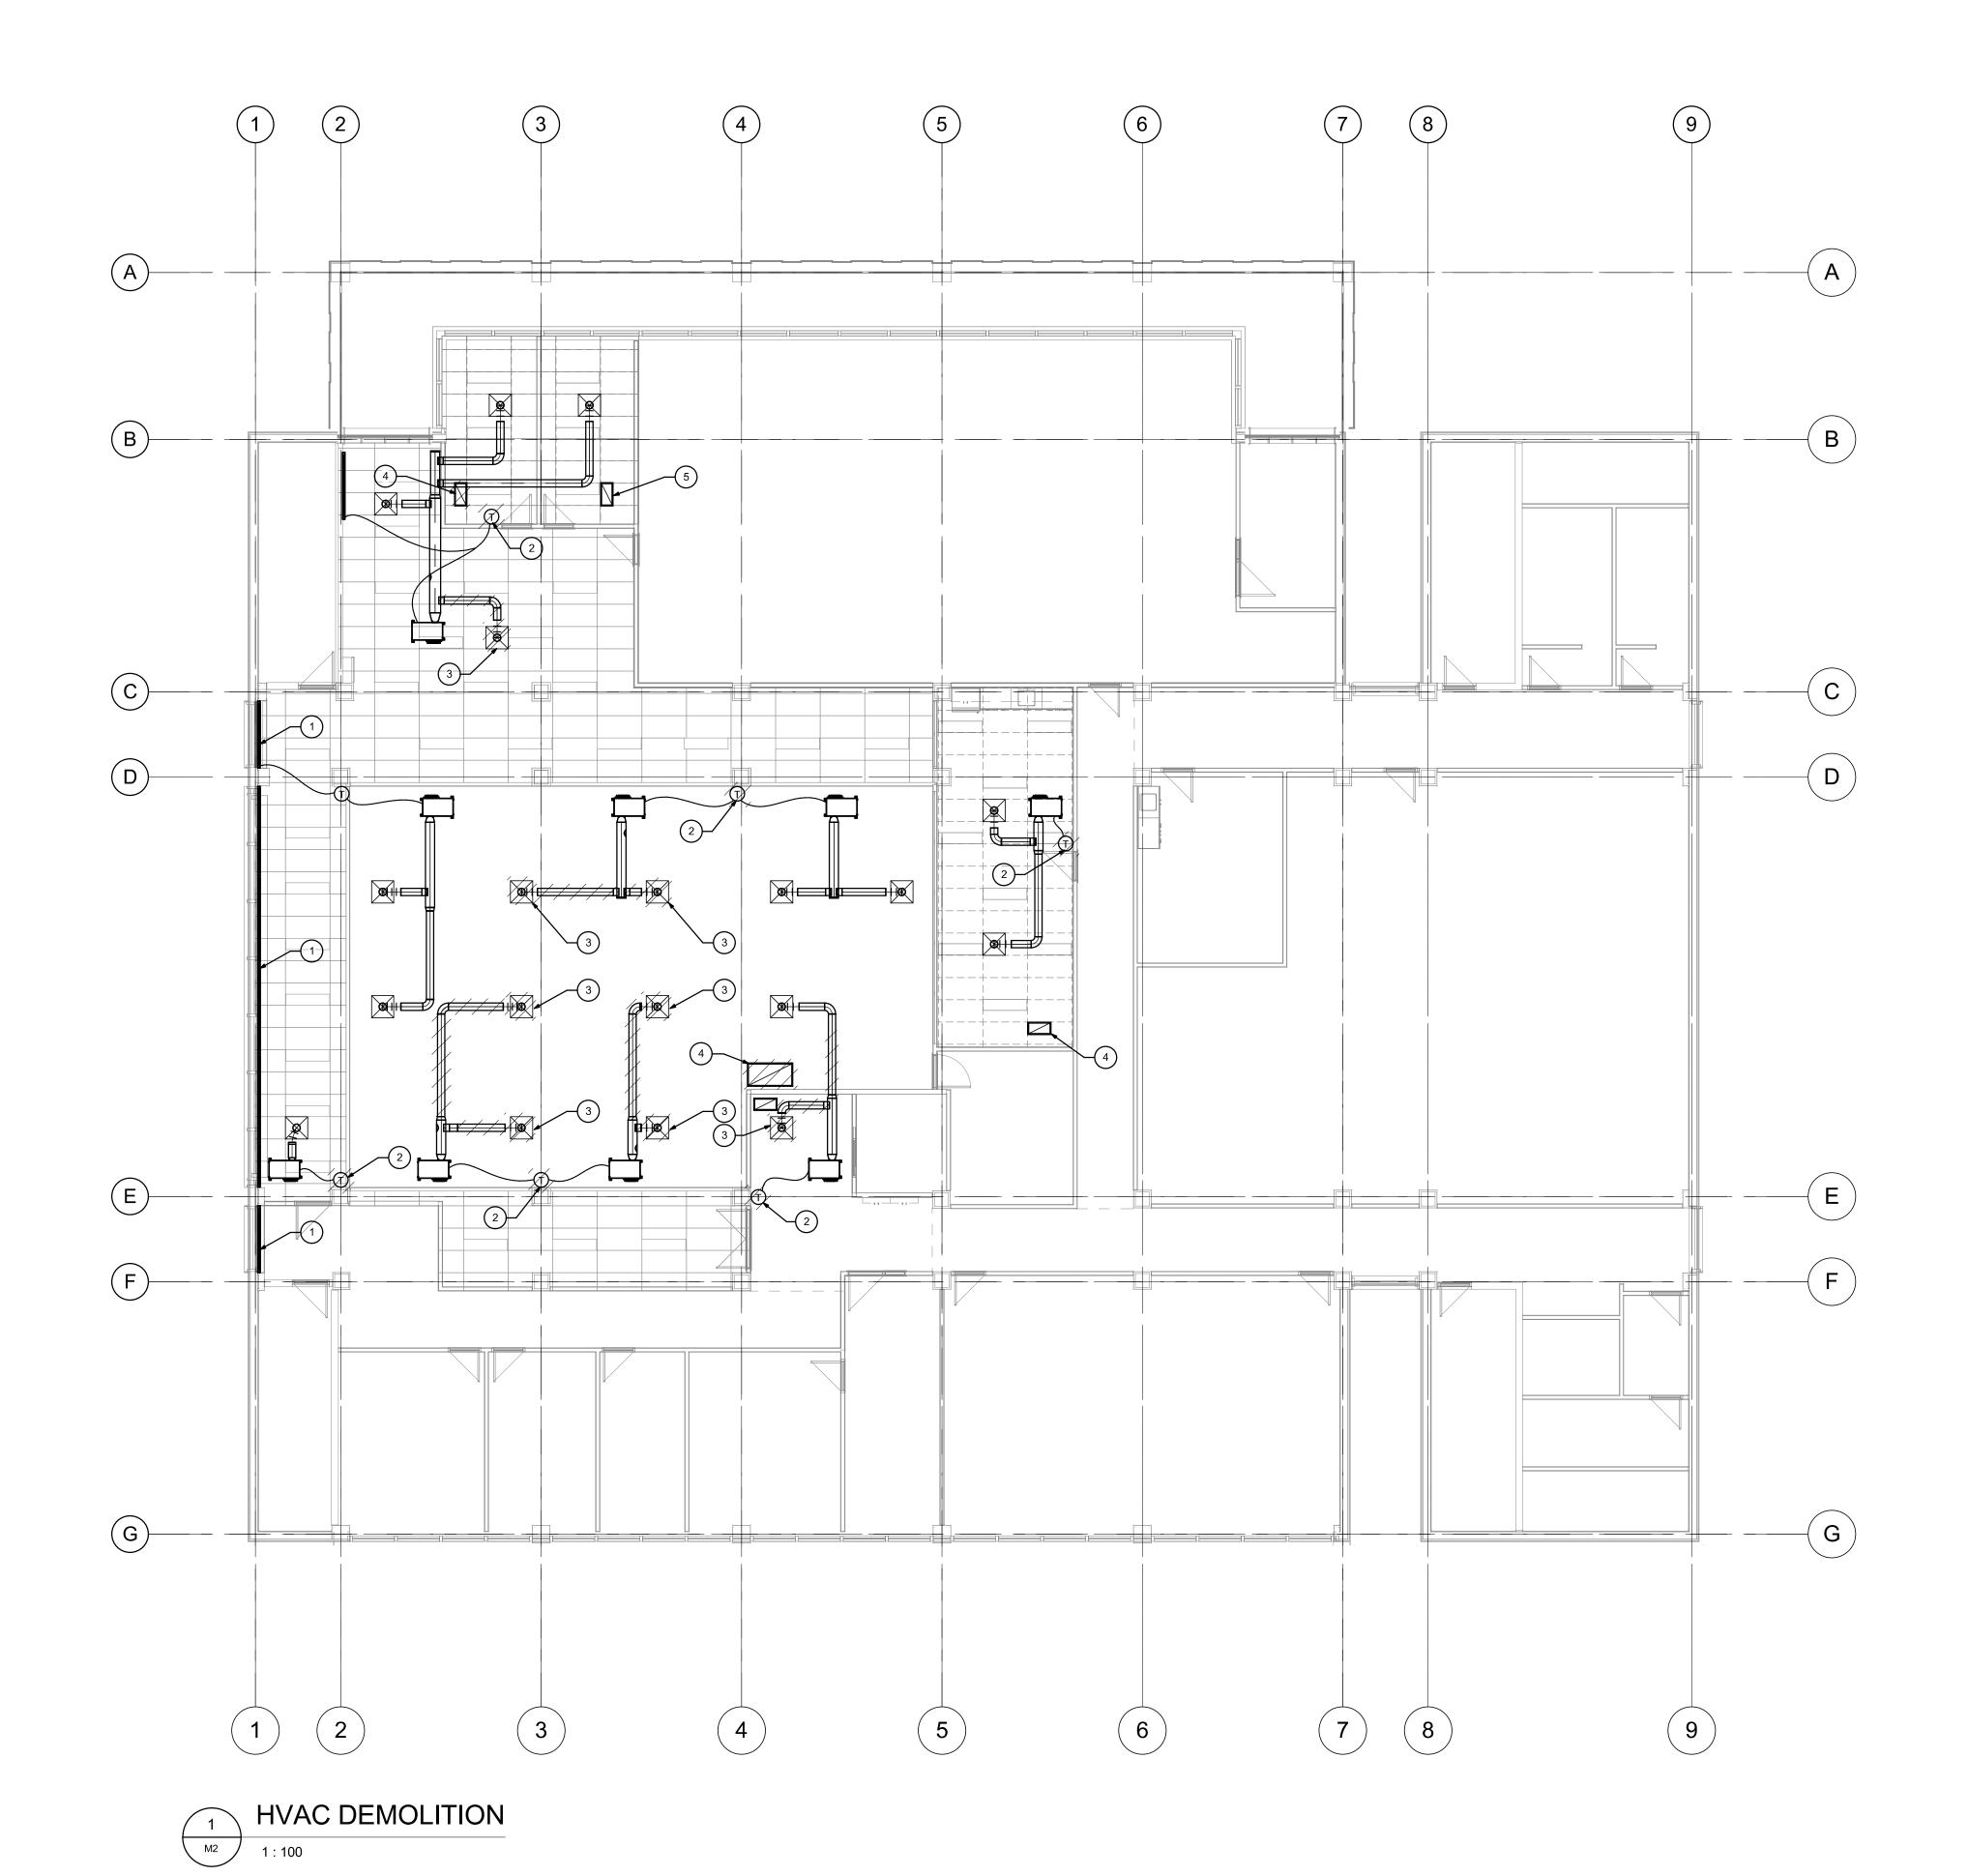
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PROJECT: 11785







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- 4. ALL WORK SHALL COMPLY WITH THE MOST CURRENT VERSION OF APPLICABLE CODES AND STANDARDS, WHICH SHALL BE CONSIDERED PART OF THIS SPECIFICATION. IN THE CASE OF CONFLICTING REQUIREMENTS, THE MOST STRINGENT REGULATIONS SHALL PREVAIL.

DRAWING NOTES:

- 1 EXISTING BASEBOARD HEATER TO REMAIN.
- 2 EXISTING THERMOSTAT TO BE RELOCATED.
- (3) EXISTING DIFFUSER TO BE RELOCATED.
- (4) EXISTING RETURN AIR GRILLE TO BE RELOCATED.
- (5) EXISTING RETURN AIR GRILLE TO REMAIN.

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REVISION	DATE	DESCRIPTION

J.D.E.SCHE

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PROJECT NAME:

CBRE - LU Chancellor Paterson Library

Teachers Common Renovations

SHEET TITLE:

HVAC DEMOLITION

DATE: 08/21/17

DRAWN: AB

PROJECT: 11785

M2





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- 8. PROVIDE CAP ON ALL PIPING TO PREVENT DEBRIS ENTERING SYSTEM.
- 9. PROVIDE PROWRAP (TM) OR APPROVED EQUAL ON ALL EXPOSED PIPING UNDER BARRIER FREE LAVATORIES AND

DRAWING NOTES:

1) EXISTING DCW, DHW, DHW RECIRC, SANITARY AND VENT PIPING TO BE MODIFIED/EXTENDED TO SUIT NEW SINK LOCATION.

PLUMBING FIXTURE SPECIFICATIONS

SK-1 FRANKE MODEL LBD6407-1 DOUBLE COMPARTMENT SELF-RIMMING DROP-IN SINK WITH FAUCET LEDGE. 20 GAUGE (0.9MM, TYPE 302 (CNS 18/8) STAINLESS STEEL, EXPOSED SURFACES ARE #4 SATIN FINISHED. SPILLWAY® BETWEEN BOWLS. UNDERCOATED TO REDUCE CONDENSATION AND RESONANCE. INCLUDES WASTE FITTINGS, FACTORY APPLIED RIM SEAL, CUTOUT TEMPLATE, AND FACTORY INSTALLED FASTENERS. CENTER BACK WASTE LOCATION INCLUDES 31/2" (89MM) CRUMB CUP STRAINER WITH 11/2" (DN38) BRASS TAILPIECE, WITH SPILLWAY. DIMENSIONS: 201/2" (52CM) X 311/4" (79CM) X 7" (18CM)DELTA MODEL 100LF-HDF SINGLE HANDLE KITCHEN DECK FAUCETS FOR EXPOSED MOUNTING ON THREE HOLE SINKS. ALL METAL FABRICATED BODY. 8 11/16" (221 MM) LONG SPOUT SWINGS 180 DEGREES. 1.5 GPM (5.7 L\MIN) VANDAL RESISTANT AERATOR. LEVER HANDLE SHALL RETURN TO NEUTRAL POSITION WHEN FAUCET IS TURNED OFF. RED AND BLUE ON HANDLE TO INDICATE HOT/COLD TEMPERATURE. CONTROL MECHANISM SHALL BE THE DIAMOND COATED CERAMIC CARTRIDGE. ADJUSTABLE HANDLE LIMIT STOP. 3/8" O.D. STRAIGHT, STAGGERED COPPER SUPPLY TUBES WITH 3/8" FITTINGS. MOUNTS ON STANDARD 13/8" (35 MM) DIAMETER HOLES ON 8" (203 MM) CENTERS, CHROME FINISH, PROVIDE 1½" P-TRAP, BRAIDED BASIN SUPPLIES, ESCUTCHEON PLATES, POINT OF USE MIXING VALVE AND ¼ TURN TAMPER PROOF ISOLATION VALVES.

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Teachers Common Renovations


SHEET TITLE:

PLUMBING RENOVATION

DATE: 08/21/17 PROJECT: 11785

PLUMBING RENOVATION



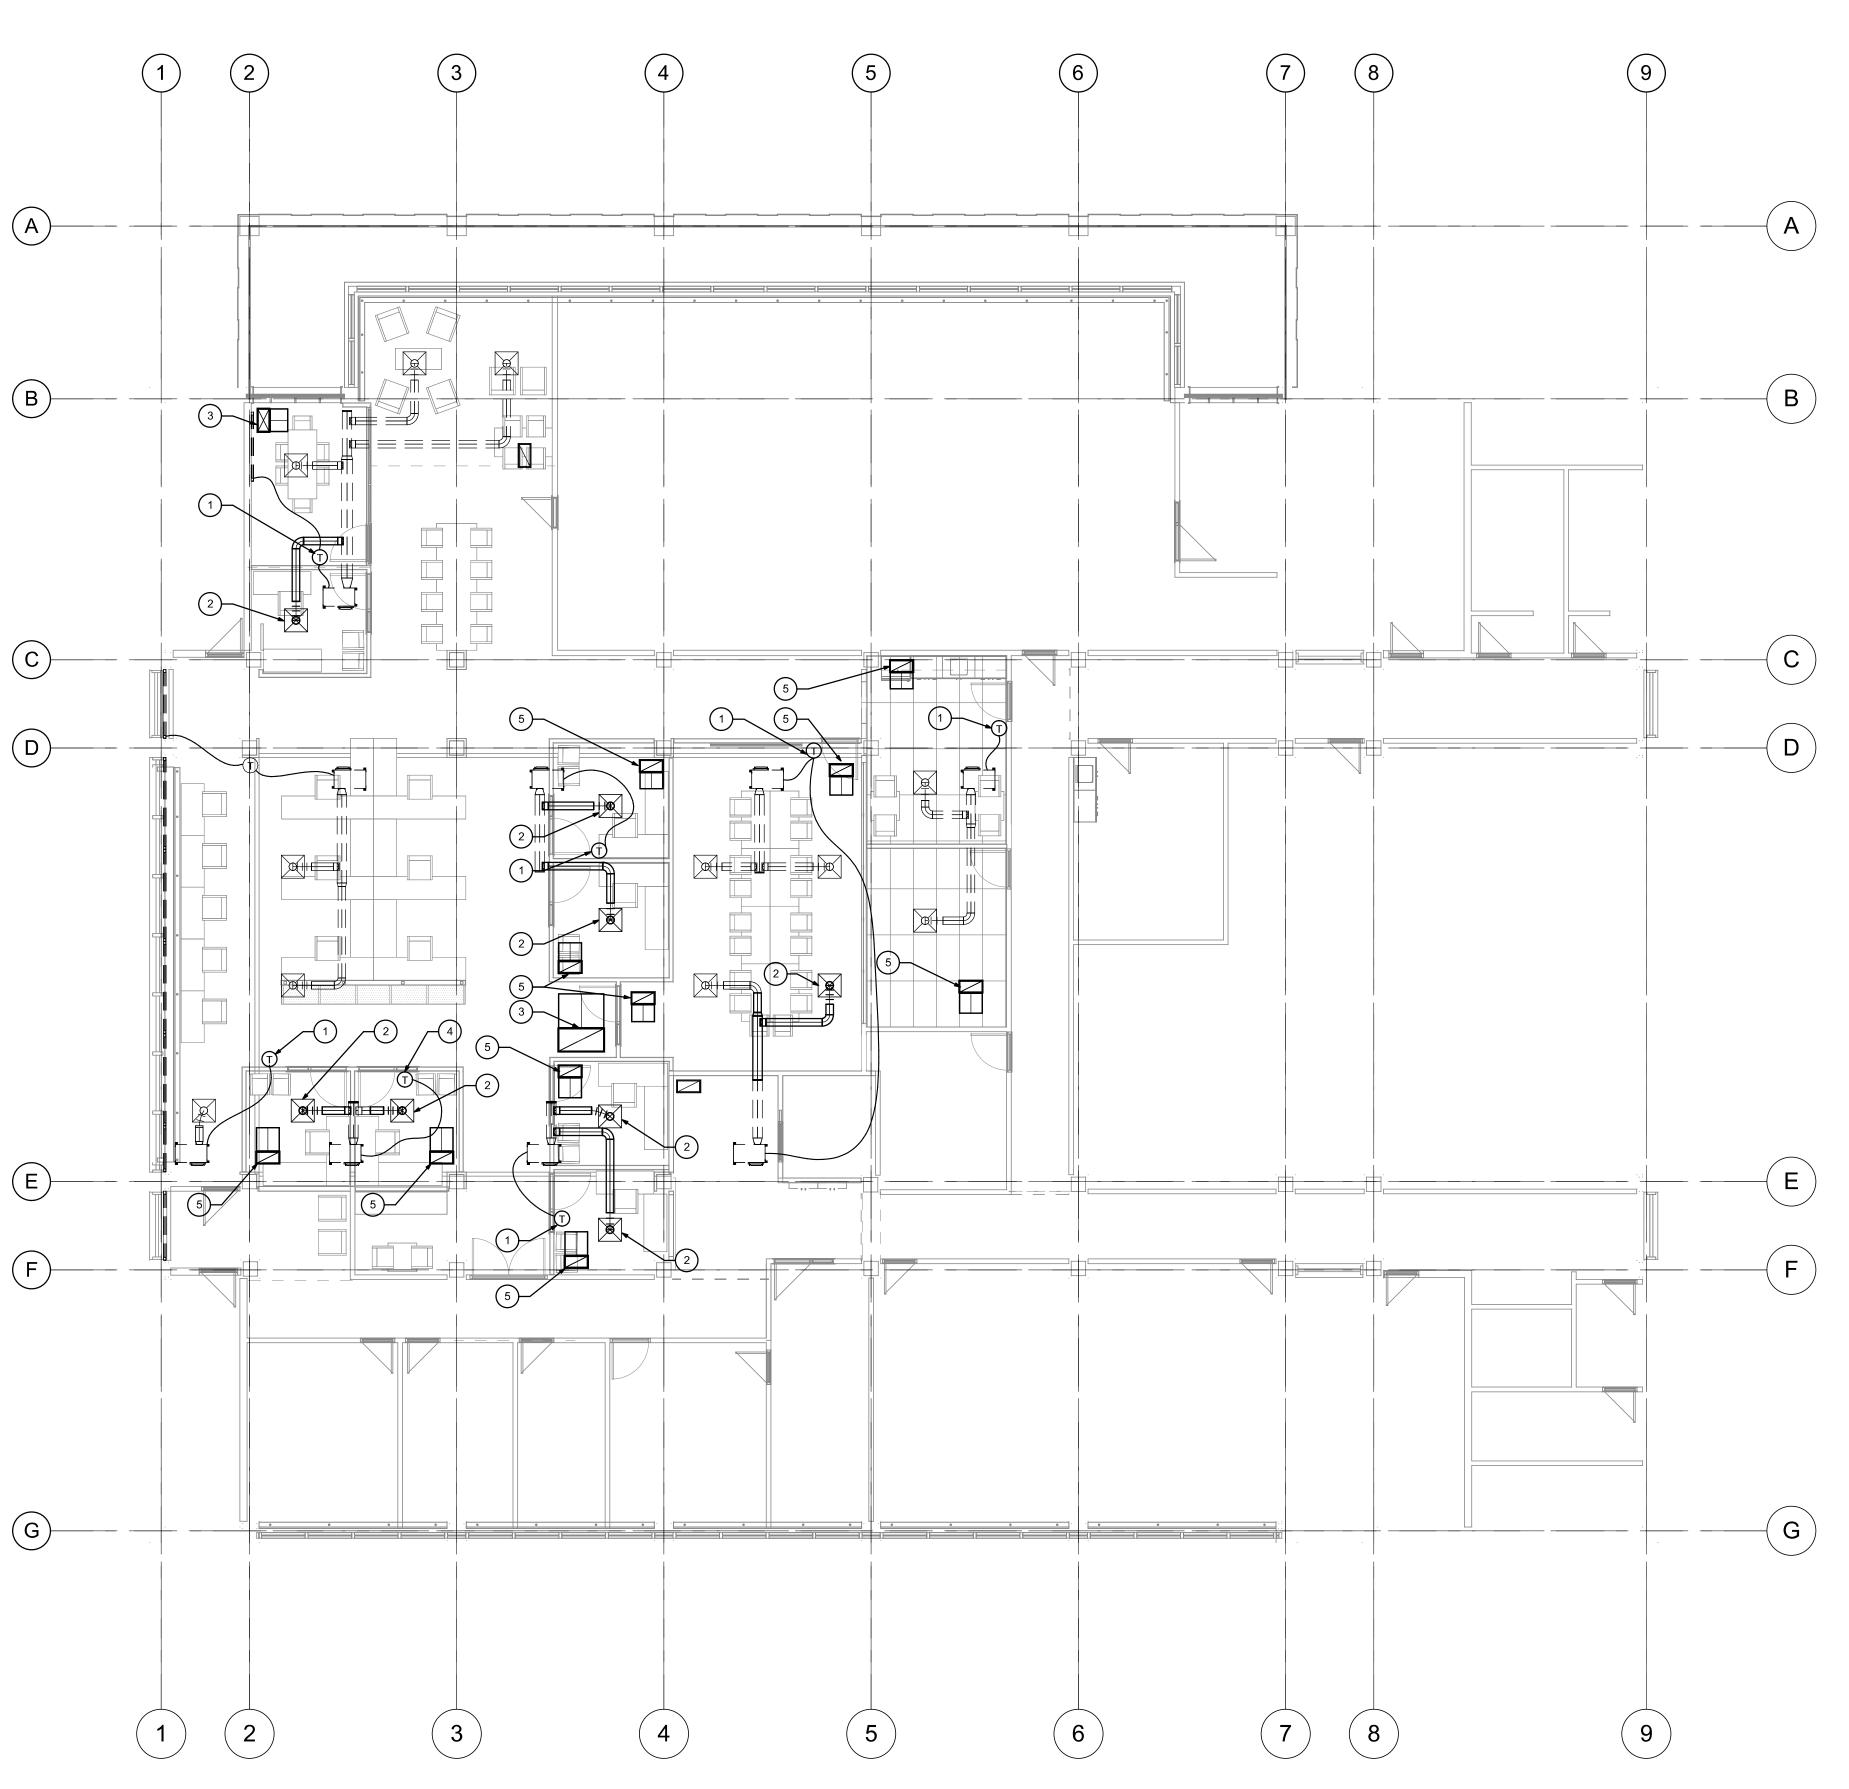


GENERAL NOTES


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- 5. COORDINATE FINAL LOCATION OF SUPPLY, RETURN AND EXHAUST DIFFUSERS ON SITE WITH FINAL LIGHTING LAYOUT, ARCHITECTURAL CEILING, STRUCTURAL, ELECTRICAL, FIRE PROTECTION AND MECHANICAL SYSTEMS.
- FLARE DUCTWORK AS REQUIRED TO SUIT CONNECTION SIZE OR OPENING SIZE TO MECHANICAL EQUIPMENT.
- PROVIDE BALANCING DAMPERS FOR EACH SUPPLY/EXHAUST OUTLET TO FACILITATE PROPER BALANCING OF THE SYSTEM.
- 8. ALL DUCT DIMENSIONS DENOTED REFER TO INTERNAL OPEN AREA OF THE
- 9. PROVIDE FIRE DAMPERS AT EACH LOCATION WHERE A DUCT PENETRATES A FIRE SEPARATION OR FIRE WALL. REFER TO ARCHITECTURAL FOR LOCATIONS OF FIRE SEPARATIONS AND FIRE WALLS, AND THEIR RATINGS.
- ENSURE INSTALLATIONS OF MATERIALS AND EQUIPMENT ALLOWS FOR ACCESS FOR TESTING, OPERATION AND MAINTENANCE.
- 11. PROVIDE AND INSTALL PULLEYS AND SHEAVES AS REQUIRED FOR THE MAIN LIBRARY AHU TO ADD AN ADDITIONAL 150 CFM (71 L/S TO THE FIFTH FLOOR DISTRIBUTION. IN THE INSTANCE WHERE VFD'S ARE INSTALLED, SET THE FLOW VIA THE VFD. RECORD THE FINAL SET POINTS IN THE BALANCING REPORT. ADJUST THE FIFTH FLOOR BALANCING DAMPERS LOCATED BY THE MAIN WASHROOM AND BEHIND THE ELEVATOR.

DRAWING NOTES:

- 1 RELOCATED THERMOSTAT. EXTEND/MODIFY CONTROL WIRING AS REQUIRED TO SHIT NEW LOCATION
- 2 RELOCATED DIFFUSER. EXTEND/MODIFY DUCTWORK AS REQUIRED TO SUIT NEW LOCATION. CLEAN DIFFUSER BEFORE RE-INSTALLATION.
- RELOCATED RETURN AIR GRILLE. CLEAN GRILLE BEFORE RE-INSTALLATION. GRILLE TO HAVE ACOUSTICALLY LINED RETURN AIR ELBOW INSTALLED.
- 4 NEW TEMPERATURE SENSOR INTEGRATED INTO THE UNIVERSITIES JOHNSON METASYS AUTOMATION SYSTEM.
- 5 NEW 24X12 RETURN GRILLE PRICE MODEL 80/CH/B12 OR EQUAL. GRILLE TO HAVE ACOUSTICALLY LINED RETURN AIR ELBOW INSTALLED.

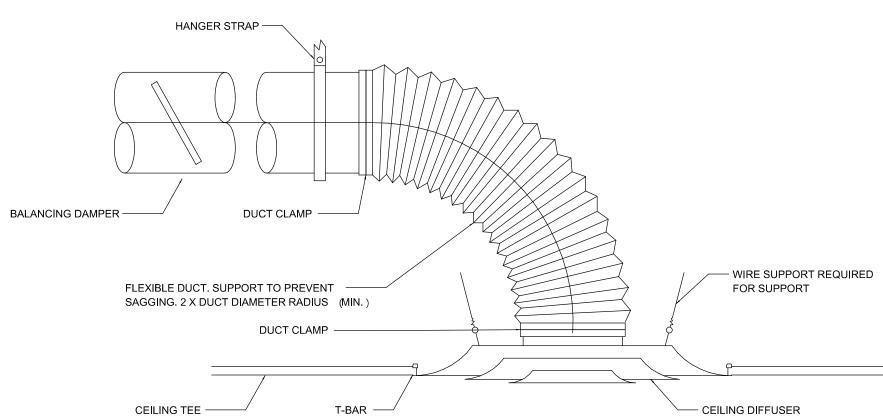



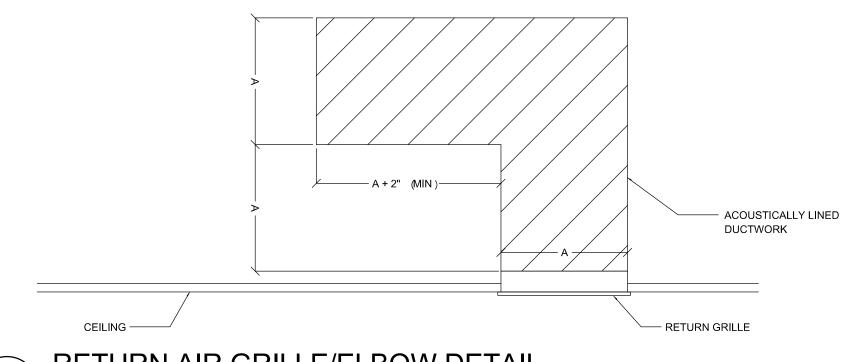

RETURN AIR GRILLE/ELBOW DETAIL

1 : 50

DATE: 08/21/17

2017.08.21 Issued for Tender

DATE

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PROJECT NAME:

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2017.07.14 Issued for Client Review

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Teachers Common Renovations

HVAC RENOVATION

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M4

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HVAC RENOVATION

22 00 00 GENERAL REQUIREMENTS

THE SPECIFICATION COVERING THE GENERAL CONDITIONS OF THE CONTRACT, SUPPLEMENTARY CONDITIONS, GENERAL AND SAFETY REQUIREMENTS, INSTRUCTIONS TO BIDDERS, AND ALL SECTIONS FORM AN INTEGRAL PART OF THIS SPECIFICATION AND SHALL BE READ IN CONJUNCTION HEREWITH. 2. DIVISION 21, 22, 23 AND 25 SHALL COMPLY WITH THE GENERAL REQUIREMENTS LISTED HEREIN.

1. PROVIDE ALL MATERIALS, LABOUR, PLANT AND EQUIPMENT REQUIRED FOR A COMPLETE AND WORKING INSTALLATION AS HEREIN SPECIFIED AND AS SHOWN ON THE DRAWINGS 2. THE INSTALLATION SHALL BE IN ACCORDANCE WITH THE CURRENT EDITION OF THE PROVINCIAL AND MUNICIPAL CODES AND REGULATIONS.

3. ALL EQUIPMENT SUPPLIED UNDER THIS CONTRACT SHALL BE NEW AND C.S.A. APPROVED. 4. ARRANGE FOR, AND COORDINATE, ROUGH-IN AND FINAL INSPECTIONS WITH INSPECTION AUTHORITY AND CONSULTANT

5. IN THE EVENT OF CONFLICT BETWEEN CONTRACT DOCUMENTS AND CODES, THE MORE STRINGENT REQUIREMENT SHALL BE ADHERED TO AT NO ADDITIONAL COST. 6. ENGINEERING SITE REVIEWS: CONTRACTOR'S WORK SHALL BE PERIODICALLY REVIEWED BY THE CONSULTANT FOR DETERMINING GENERAL QUALITY OF INSTALLATION, GUIDANCE WILL BE OFFERED AS TO INTERPRETATION OF CONTRACT DOCUMENTS AND TO ASSIST IN PERFORMING THE INSTALLATION. INSPECTIONS, REVIEWS AND DIRECTIVES ISSUED IN NO WAY RELIEVE THE CONTRACTOR, HIS AGENTS, EMPLOYEES OR SUBTRADES FROM CONTRACTUAL OBLIGATIONS. CONFORMANCE TO CODES OR SAFE AND RECOGNIZED PRACTICES. 7. APPLY FOR AND PAY FOR ALL REQUIRED PERMITS, LICENSES, INSPECTIONS AND FEES.

8. INDICATE ALL PERMIT NUMBERS ON ALL PROGRESS DRAWS. 9. WHERE NO PERMIT WAS APPLIED FOR INDICATE SAME ON PROGRESS DRAW.

1.2 DEFINITIONS

THE FOLLOWING ARE DEFINITIONS OF TERMS AND EXPRESSIONS USED IN THE ELECTRICAL AND MECHANICAL SPECIFICATION: . INSPECTION AUTHORITY MEANS AGENT OF ANY AUTHORITY HAVING JURISDICTION OVER CONSTRUCTION STANDARDS ASSOCIATED WITH ANY PART OF WORK ON SITE. 2. PROVIDE MEANS TO SUPPLY, INSTALL AND LEAVE IN WORKING ORDER ALL MATERIALS AND NECESSARY DEVICES TO ENSURE A FULLY FUNCTIONAL SYSTEM. TESTED AND COMPLETE IN EVERY WAY, UNLESS OTHERWISE NOTED. 3. THE TERM "CONSULTANT" OR "OWNER'S REPRESENTATIVE" REFERS TO:

MCW/AGE CONSULTING PROFESSIONAL ENGINEERS 210 - 1821 WELLINGTON AVENUE WINNIPEG, MANITOBA R3H OG4

PHONE: (204) 779 7900

4. THE TERM "CONTRACTOR" REFERS TO THE SUCCESSFUL BIDDER ENGAGED TO PERFORM THE INSTALLATION AND TO COORDINATE ALL SUB TRADES ENGAGED BY THE "CONTRACTOR". THE TERM "DRAWINGS" AND "SPECIFICATIONS" ARE COMPLEMENTARY TO EACH OTHER. WHAT IS CALLED FOR BY ONE SHALL BE BINDING TO BOTH.

6 THE TERM "CONTRACT DOCUMENTS" REFERS TO BOTH DRAWINGS AND SPECIFICATIONS 7. STANDARDS, REGULATIONS AND BYLAWS, HEREAFTER REFERRED TO AS CODES.

E-MAÌL: MCW_WPG@MCW.COM

1.3 REQUEST FOR INFORMATION

1. ALLOW TEN (10) FULL WORKING DAYS FOR MCW/AGE CONSULTING PROFESSIONAL ENGINEERS TO RESPOND TO ALL REQUESTS FOR INFORMATION. 2. TRADE CONTRACTOR SHALL REVIEW AND APPROVE ALL REQUESTS FOR INFORMATION (RFI'S) FROM SUB-CONTRACTORS PRIOR TO SUBMISSION.

3. GENERAL CONTRACTOR SHALL REVIEW AND APPROVE ALL RFI'S PRIOR TO SUBMITTAL TO ENSURE INFORMATION IS NOT ALREADY INCLUDED IN CONTRACT DOCUMENTS OR CANNOT BE REASONABLY INFERRED FROM CONTRACT DOCUMENTS.

1.4 SHOP DRAWINGS

. SUBMIT ELECTRONIC SHOP DRAWINGS FOR REVIEW BY THE CONSULTANT PRIOR TO ORDERING EQUIPMENT AND COMMENCING WORK. SHOP DRAWINGS SHALL BE SPECIFIC TO THE EQUIPMENT AND MATERIALS FOR THIS PROJECT, CHANGES TO LOCATION AND ARRANGEMENT SHALL BE REVIEWED PRIOR TO INSTALLATION, REVIEW OF SHOP DRAWINGS BY THE CONSULTANT IS FOR THE SOLE PURPOSE OF ASCERTAINING CONFORMANCE TO DESIGN INTENT, CONTRACTOR RETAINS RESPONSIBILITY FOR ALL ASPECTS OF INSTALLATION, PERFORMANCE AND COORDINATION

2. SHOP DRAWING PROCEDURES ARE AS FOLLOWS: . GENERAL CONTRACTOR AND TRADE CONTRACTOR SHALL REVIEW, APPROVE AND STAMP SUBMITTALS PRIOR TO SENDING TO MCW/AGE CONSULTING PROFESSIONAL ENGINEERS FOR REVIEW. SUBMITTALS

WITHOUT CONTRACTOR STAMPS WILL BE REJECTED. 2. A TRANSMITTAL LISTING EACH ITEM OF EQUIPMENT SHALL ACCOMPANY EACH SUBMISSION 3. EQUIPMENT MUST BE LABELED APPROPRIATELY. EACH ITEM OF EQUIPMENT MUST BEAR THE IDENTIFIER USED ON THE DRAWINGS

4. DATA SHEETS MUST CLEARLY INDICATE MODEL AND OPTIONS BEING UTILIZED. ALL INFORMATION THAT DOES NOT APPLY MUST BE CROSSED OFF. 5. ALLOW MCW/AGE CONSULTING PROFESSIONAL ENGINEERS TEN (10) FULL WORKING DAYS TO REVIEW ALL SHOP DRAWINGS.

6. SEND ELECTRONIC SHOP DRAWING SUBMITTALS (.PDF ONLY) TO WPG.SHOPDRAWINGS@MCW.COM ONLY: PLEASE DO NOT COPY STAFF MEMBERS DIRECTLY. 7. ALL DEVIATIONS FROM SPECIFIED EQUIPMENT SHALL BE HIGHLIGHTED BY CONTRACTOR.

1.5 ACCURACY OF DATA

DRAWINGS ARE SCHEMATIC: EXACT LOCATIONS, DISTANCES, LEVELS AND OTHER DIMENSIONS SHALL BE GOVERNED BY THE ARCHITECTURAL AND/OR INTERIOR DESIGN DRAWINGS 2. DEVICES OR EQUIPMENT SHALL BE MOVED TO ANY POINT WITHIN A 3M (10'-0") RADIUS FOR COORDINATION PURPOSES OR WHEN THE CONSULTANT REQUESTS RELOCATION BEFORE THE WORK HAS BEEN SUBSTANTIALLY COMPLETED. WITHOUT ADDITIONAL COST

3. PROVIDE A TYPICAL MOCK-UP OF ONE AREA. IF REQUESTED. 4. DRAWINGS AND SPECIFICATIONS ESTABLISH SCOPE OF WORK ONLY AND ARE NOT DETAILED INSTALLATION INSTRUCTIONS. FOLLOW MANUFACTURER'S RECOMMENDATIONS AND ADHERE TO ALL

5. THE CONSULTANT SHALL HAVE THE FINAL SAY IN MATTERS OF INTERPRETATION.

16 FXAMINATION

1. EXAMINE ENTIRE CONTRACT DOCUMENT PACKAGE TO ENSURE THAT THE WORK UNDER THIS CONTRACT CAN BE SATISFACTORILY CARRIED OUT, REPORT ANY DISCREPANCIES TO THE CONSULTANT PRIOR TO SUBMISSION OF TENDER. 2. EXAMINE THE SITE, LOCAL CONDITIONS AND ALL EXISTING APPARATUS IF ANY TO BE RE-USED AND

CONSTRUCTION. 1.7 WORKMANSHIP

1. INSTALL EQUIPMENT IN A WORKMANLIKE MANNER TO PRESENT A NEAT APPEARANCE TO THE SATISFACTION OF THE CONSULTANT, INSTALL EQUIPMENT PARALLEL AND PERPENDICULAR TO BUILDING LINES. INSTALL NEATLY AND GROUP TO PRESENT A TIDY APPEARANCE. 2. INSTALL EQUIPMENT AND APPARATUS INCLUDING BUT NOT LIMITED TO JUNCTION BOXES, VALVES AND BALANCING DAMPERS REQUIRING MAINTENANCE, ADJUSTMENT OR EVENTUAL REPLACEMENT WITH ADEQUATE CLEARANCES AND ACCESSIBILITY FOR SAME, ACCESSIBILITY IS DEEMED TO BE WITHIN 600MM (24") OF ACCESSIBLE DRYWALL CEILING OPENING AND NO MORE THAN 1M (39") ABOVE ACT

ÆRIFY THAT THE CONDITION OF THIS EQUIPMENT IS SUITABLE FOR ITS INTENDED USE IN THE NEW

3. INCLUDE IN THE WORK, ALL REQUIREMENTS SHOWN ON THE SHOP DRAWINGS OR MANUFACTURERS' INSTALLATION INSTRUCTIONS.

4. REPLACE WORK UNSATISFACTORY TO THE CONSULTANT WITHOUT EXTRA COST. 5. EQUIPMENT EXPOSED TO EXTERIOR WEATHER AND / OR MOISTURE SHALL BE CORROSION AND UV 6 ONLY SKILLED AND QUALIFIED LICENSED TRADESPERSON SHALL PERFORM THE WORK TRADESPERSON SHALL PROVIDE PROOF OF REGISTERED STATUS WHEN REQUESTED.

WORK, VERIFY ALL SERVICES, CONNECTION POINTS, AND ALL ACCESS OPENINGS TO PERMIT INSTALLATION OF NEW EQUIPMENT.

1.8 COORDINATION CONTRACTOR SHALL CO-ORDINATE ALL ASPECTS OF THE INSTALLATION WITH ALL OTHER TRADES. THERE SHALL BE NO CHANGE NOTICES ISSUED NOR CHANGES TO THE BUILDING DESIGN (I.E. LOWERING CEILING HEIGHTS) DUE TO ROUTING CONFLICTS AMONGST TRADES OR LACK OF COORDINATION. WHEN REQUIRED, DISCUSS THE PROPOSED ROUTING WITH THE CONSULTANT PRIOR TO INSTALLATION, FINAL RESPONSIBILITY REMAINS WITH THE CONTRACTOR.

7 CONTRACTOR IS RESPONSIBLE TO CAREFULLY EXAMINE CONDITIONS AT THE INTENDED PLACE OF

2. CONNECT TO EQUIPMENT SPECIFIED IN OTHER SECTIONS, INSTALLED BY OTHER CONTRACTORS OR 3. SUPPLY ACCESS DOORS OR RATED DOORS TO MATCH FIRE RATING, AT ALL SERVICE POINTS FOR EQUIPMENT. INDICATE ON PROJECT RECORD DOCUMENTS THE LOCATION OF ALL ACCESS DOORS.

4. OPENINGS SHALL BE COORDINATED WITH THE GENERAL CONTRACTOR. OPENING SIZES SHALL BE KEPT TO A MINIMUM 5. CONTRACTOR SHALL PAY FOR PROFESSIONAL TRADE TO PATCH OPENINGS AND INSTALL ALL FINISHING MATERIALS (I.E. DRYWALL, BRICK, ETC.), OPENINGS WITH POTENTIAL TO COMPROMISE THE STRUCTURE SHALL BE APPROVED BY A LICENSED STRUCTURAL ENGINEER PRIOR TO STARTING THE OPENING. THE CONTRACTOR SHALL CONTACT THE STRUCTURAL CONSULTANT FOR INSTRUCTIONS PRIOR TO CUTTING OR CORING. CONTRACTOR IS TO SCAN STRUCTURE BEFORE MAKING OPENINGS

AND ADVISE GENERAL CONTRACTOR AND CONSULTANT OF ANY OBSTRUCTIONS FOUND PRIOR TO CUTTING OR CORING 6. ELECTRIC MOTORS EQUIPPED WITH VARIABLE SPEED CONTROLLER AS SUPPLIED BY MECHANICAL CONTRACTOR SHALL BE INSTALLED. WIRED AND CONNECTED BY ELECTRICAL CONTRACTOR. 7. VARIABLE FREQUENCY DRIVES (VFD) - ELECTRIC MOTORS AND CABLING SHALL BE COMPATIBLE WITH

VARIABLE FREQUENCY DRIVES. 8. DIRECT DRIVES - ELECTRIC MOTORS SHALL BE EQUIPPED WITH VARIABLE SPEED CONTROLLER CAPABLE OF INFINITE MODULATION BETWEEN 30% TO 100%.

1.9 SUPERVISION

1. SUPERVISE THE WORK AT ALL TIMES THROUGH A RESPONSIBLE AND COMPETENT QUALIFIED 2. FULL CO-OPERATION SHALL BE SHOWN WITH OTHER TRADES TO FACILITATE INSTALLATIONS AND TO AVOID DELAYS IN CARRYING OUT THE WORK.

1.10 PROJECT CLOSE OUT . PROJECT RECORD DOCUMENTS

> I. MAINTAIN ACCURATE PROJECT RECORD DOCUMENTS AND CURRENT ON SITE AND SAME SHALL BE PRESENT FOR REVIEW AT EACH SITE REVIEW. SUBMIT THESE PROJECT RECORD DOCUMENTS IN ELECTRONIC FORMAT OF SAME PROGRAM AND VERSION OF ORIGINAL CONTRACT DOCUMENTS AND PDF FOR REVIEW AT THE COMPLETION OF THE PROJECT. NOTE THAT CHANGES TO ARCHITECTURAL,

AND STRUCTURAL AND CIVIL FLOOR PLANS MUST BE INCLUDED. 2. A MINIMUM OF \$1,000.00 PER DRAWING SHALL BE HELD-BACK UNTIL ALL PROJECT RECORD

DOCUMENTS ARE SUBMITTED AND DEEMED COMPLETE.

TRANSFER CHANGES TO ELECTRONIC DISC AUTOCAD FILE. SUBMIT DISC AND HARD COPY FOR FINAL REVIEW AND SUBMISSION TO OWNERS.

4. AFTER ACCEPTANCE OF PROJECT RECORD DOCUMENTS BY THE CONSULTANT, PROVIDE ONE (1) COMPLETE SET OF AUTOCAD AND PDF PROJECT RECORD DOCUMENTS ON THREE (3) CD-ROM AND ONE (1) SET OF HARD COPY DESIGN PRINTS AND ONE (1) SET OF HARD COPY RED LINE CONTRACTOR

1. MECHANICAL SHALL INCLUDE ROUTING OF EQUIPMENT

 LOCATIONS OF VALVES CONCEALED EQUIPMENT AND ACCESS PANELS; AND

4. ACCURATE LOCATIONS FOR IN OR UNDER SLAB ITEMS. (IE. DRAINS, PIPING ROUTING, DUCT 5. MCW/AGÉ CONSULTING PROFESSIONAL ENGINEERS CAN COMPLETE THE PROJECT RECORD DOCUMENTS FROM CONTRACTOR'S RED-LINED MARKUPS FOR A FEE OF \$250.00 PER DRAWING.

VITH A PROJECT MINIMUM OF \$1,000.00. 6. THE USE OF WHITE OUT (LIQUID OR TAPE) SHALL BE USED FOR CORRECTING CONTRACTOR RED LINE ERRORS ONLY. 7. DO NOT USE WHITE OUT TO DELETE ORIGINAL CONTRACT DRAWINGS DELETED ITEMS SHALL BE CROSSED OUT IN RED INK 8. ME SCHEDULES AND SHEETS SHALL BEAR A WATERMARK, INDICATING "REFER TO O&M".

2. OPERATION AND MAINTENANCE MANUALS PRIOR TO REQUESTING ANY SUBSTANTIAL PERFORMANCE SITE REVIEW, ALL ASPECTS OF THE INSTALLED SYSTEM SHALL BE COMPLETE AND OPERATIONAL. TESTING AND BALANCING SHALL BE COMPLETE ALONG WITH DEVICE AND EQUIPMENT IDENTIFICATION, EQUIPMENT STARTUPS. 2. AT THE COMPLETION OF WORK SUBMIT THREE (3) ELECTRONIC MEDIA STORAGE DEVICE AND ONE (1)

HARD COVERED LOOSE LEAF BINDER SHOWING ALL MAJOR COMPONENTS AND DIVIDED BY TRADE SECTIONS, MANUALS SHALL BE COMPLETE WITH ALL WARRANTY INFORMATION, INSTRUCTIONS FOR OPERATION, MAINTENANCE, AND REPLACEMENT PARTS AS REQUIRED. INCLUDE COPIES OF REVIEWED SHOP DRAWINGS, CONSULTANT CONTACT INFORMATION, CONTRACTOR AND SUB-CONTRACTOR INFORMATION. INCLUDE COPIES OF VALVE TAG LISTS, ALL INSPECTION CERTIFICATES, AND BALANCING REPORTS. THE CONSULTANT MAY NOT PERFORM FINAL INSPECTIONS NOR CERTIFY FOR OCCUPANCY UNTIL THE O&M MANUALS ARE RECEIVED, REVIEWED AND APPROVED.

. INCLUDE PERFORMANCE CURVES, DETAILED DRAWINGS, PART LISTS, SUPPLIER INFORMATION AND ANY OTHER PERTINENT DATA 2. PROVIDE MANUFACTURERS START-UP REPORTS AND LETTERS OF CERTIFICATION THAT THE FOLLOWING MECHANICAL EQUIPMENT AND SYSTEMS ARE STARTED, COMMISSIONED AND WORKING CORRECTLY:

1. CONTROLS: 2. AIR MOVING EQUIPMENT

3. PLUMBING FIXTURES, MIXING VALVES AND BRASS; 3. EACH OF THE CONTRACTORS SHALL INSTRUCT THE OWNERS OPERATING STAFF ON THE OPERATION, MAINTENANCE, AND ADJUSTMENT OF EQUIPMENT AND/OR SYSTEM THAT THEY HAVE INSTALLED OR SET. PROVIDE SIGN OF SHEETS FOR TRAINING INDICATING WHO WAS TRAINED AND NUMBER OF HOURS OF 4. SPARE PARTS:

1. PROVIDE ONE (1) SET OF SPECIAL TOOLS REQUIRED TO SERVICE EQUIPMENT AS RECOMMENDED BY MANUFACTURER. PROVIDE A RECEIPT SIGNED BY THE OWNER'S REPRESENTATIVE FOR EACH TOOL IN EACH COPY OF THE O&M MANUAL: 3 CERTIFICATION REQUIREMENTS

1. THE INSTALLATION SHALL BE COMPLETELY TESTED DEMONSTRATING THAT THE EQUIPMENT AND SYSTEMS INSTALLED PERFORM IN THE MANNER INTENDED

2. PRIOR TO MECHANICAL FINAL INSPECTION OR CERTIFICATION PROVIDE THE FOLLOWING: . COPIES OF MANUFACTURER'S STARTUP OR CERTIFICATION REPORTS; 2. TAB REPORTS:

3. DISTRIBUTION SYSTEM PRESSURE TEST REPORTS;

4. TRAINING SIGN OFF SHEETS; 5. COPY OF THE BUILDING OR PLUMBING PERMIT: AND

6. RECEIPTS OR TRANSMITTALS INDICATING OWNER HAS RECEIVED ALL SPECIAL TOOLS AND SPARE PARTS.

1. THE SATISFACTORY OPERATION OF ALL WORK AND EQUIPMENT SHALL BE WARRANTIED FOR A MINIMUM OF TWELVE (12) CALENDAR MONTHS AFTER SUBSTANTIAL COMPLETION, UNLESS OTHERWISE NOTED.

REQUEST FOR APPROVAL OF MATERIAL AS EQUALS TO THAT SPECIFIED SHALL BE SUBMITTED TO THE CONSULTANT WITH PERFORMANCE SPECIFICATIONS TWO (2) FULL WORKING DAYS BEFORE LAST ADDENDUM, SAMPLES SHALL BE PROVIDED ON REQUEST 2. APPROVALS SHALL BE TRANSMITTED ELECTRONICALLY, INCLUDE ALL PERTINENT INFORMATION FOR A COMPLETE REVIEW BY THE CONSULTANT

1.13 WORK IN EXISTING BUILDING

1. THE BUILDING SHALL REMAIN OPEN AND IN NORMAL OPERATION DURING THE CONSTRUCTION PERIOD OF 2. FLEXIBLE DUCT INSULATION (FDI): THIS CONTRACT 2. WHERE EXISTING SERVICES SUCH AS POWER, FIRE ALARM, HVAC, PLUMBING OR FIRE PROTECTION ARE REQUIRED TO BE DISRUPTED AND/OR SHUTDOWN COORDINATE THE SHUT-DOWNS WITH THE OWNER AND ALUMINUM TAPE. CARRY OUT THE WORK AT A TIME AND IN A MANNER ACCEPTABLE TO THEM. CAREFULLY SCHEDULE ALL

DISRUPTIONS AND/OR SHUTDOWNS AND ENSURE THAT THE DURATION OF SAME IS KEPT TO A MINIMUM SUBMIT FOR APPROVAL, A WRITTEN SCHEDULE OF EACH DISRUPTION AT LEAST 72 HOURS IN ADVANCE OF PERFORMING WORK AND OBTAIN OWNER'S WRITTEN CONSENT PRIOR TO IMPLEMENTING. 3 SHOULD ANY CONNECTIONS BE REQUIRED TO MAINTAIN SERVICES DURING WORK IN THE EXISTING BUILDING, SUPPLY AND INSTALL ALL NECESSARY MATERIAL AND EQUIPMENT AND PROVIDE ALL LABOUR AT NO EXTRA COST. SHOULD ANY EXISTING SYSTEM BE DAMAGED, MAKE FULL REPAIRS WITHOUT EXTRA

COST, AND TO THE SATISFACTION OF THE OWNER. 4. CONTRACTOR SHALL ENSURE THAT ANY CORING OF HOLES THROUGH THE DECK FLOORS, WALLS AND GRADE BEAMS, ETC. WILL NOT PENETRATE EXISTING CONDUITS, CABLES OR MECHANICAL EQUIPMENT IN OR UNDER THE CONCRETE. CONTRACTOR SHALL BE RESPONSIBLE TO TAKE ANY AND ALL ACTION AS DEEMED NECESSARY BY THE BUILDING ENGINEER TO CORRECT ANY SUCH PENETRATIONS AT HIS COST

NO CORING SHALL BE UNDERTAKEN UNLESS PERMISSION IS GIVEN BY THE BUILDING ENGINEER. 5. WHEN NEW CEILINGS ARE TO BE INSTALLED, EXISTING DEVICES ARE TO BE TEMPORARY REMOVED, RELOCATED, EXTENDED OR MODIFIED TO ACCOMMODATE NEW CEILING LEVEL UNLESS OTHERWISE

6. WHEN PAINTING IS TO COMMENCE, EXISTING DEVICES ARE TO BE TEMPORARY REMOVED, AND REINSTALLED UPON COMPLETION OF PAINTING UNLESS OTHERWISE NOTED

22 00 10 ACCEPTABLE MANUFACTURERS STANDARD OF MATERIAL & EQUIPMENT

1. WHERE A MANUFACTURER'S NAME IS MENTIONED, IT IS FOR THE PURPOSE OF SETTING A STANDARD OF QUALITY, PERFORMANCE, CAPACITY, APPEARANCE AND SERVICEABILITY. ACCEPTABLE MANUFACTURERS SHOWN BELOW ARE PRE-APPROVED IF THEIR PRODUCTS ARE EQUAL IN PERFORMANCE TO THE SPECIFIED ONES, AND THE PRODUCTS CAN BE USED IN THE PREPARATION OF THE TENDER. WHERE NO ALTERNATIVES HAVE BEEN APPROVED, PROVIDE THE EXACT MAKE SPECIFIED, REQUESTS FOR APPROVAL OF ALTERNATIVES MUST BE SUBMITTED TO THE CONSULTANT NOT LESS THAN THREE DAYS PRIOR TO CLOSING DATE OF THE TENDER AND SUBMISSIONS MUST BE APPROVED IN WRITING BY THE ENGINEER IN AN ADDENDUM, NO EXCEPTIONS. APPROVAL AS AN ALTERNATIVE DOES NOT ABSOLVE THE SUPPLIER AND CONTRACTOR OF THE OBLIGATION TO MEET ALL CLAUSES OF THIS SPECIFICATION.

2. DESCRIPTION:

1. PLUMBING AND DRAINAGE APPROVED LIST

ACCEPTABLE MANUFACTURERS CRANE, GRINNELL, MYATT EQUIPMENT
HANGERS AND SUPPORTS ANCON, SMITH, ZURN, MIFAB, WATTS DRAINAGE SPECIALTIES SHOCK ABSORBERS ANCON, SMITH, ZURN, PPP, WATTS PLUMBING BRASS KOHLER, DELTA COMMERCIAL, MOEN, TOTO, SLOAN

STAINLESS STEEL SINKS

2. VENTILATION APPROVED LIST EQUIPMENT
DAMPER HARDWARE, FAN CONNECTORS ACCEPTABLE MANUFACTURERS TITUS, PRICE, NAILOR INDUSTRIES, TUTTLE AND BAILEY

DIFFUSERS, REGISTERS AND GRILLES FLEXIBLE DUCTWORK

22 00 20 PIPING AND FITTINGS PROVIDE ISOLATION VALVES AT ALL FIXTURES, APPLIANCES AND EQUIPMENT

. PROVIDE CHECK STOPS AT ALL MIXING VALVES. 3. ALLOW FOR THERMAL EXPANSION ON ALL PIPING SYSTEMS CONVEYING HOT OR COLD VAPOUR OR LIQUID. 4. PROVIDE POINT OF USE THERMOSTATIC MIXING VALVES SET TO 43°C (110°F) FOR LAVATORIES WHERE

FRANKE FLKAY AMI ARISTALINE ACORN

TERMOFLEX, WIRE-MOULD, FLEX MASTER

5. TAG ALL MAJOR ZONE AND SHUT OFF VALVES WITH 38MM (11/2") DIAMETER BRASS TAGS. INDEX AND LIST VALVES, INSERT LIST IN EACH O&M MANUAL ALSO FRAME AND MOUNT COPY OF LIST IN A CONSPICUOUS AREA OF THE MECHANICAL ROOM.

6. IDENTIFY ALL EQUIPMENT WITH BLACK LAMACOID TAGS 100MM X 25MM (4"X1") WITH WHITE LETTERING. MECHANICALAFFIX TAGS TO EQUIPMENT. EQUIPMENT NAMES AND NUMBER TO MATCH THOSE LISTED

ON CONTRACT DOCUMENTS 7 IDENTIFY ALL PIPING WITH STENCILED LETTERING AND DIRECTIONAL ARROWS AT INTERVALS NO GREATER THAN 6M (20") AND AT EVERY CHANGE IN DIRECTION, LABELING AND IDENTIFICATION TO EITHER THE OWNER'S STANDARD OR THE CSA STANDARD. CONFIRM SYSTEM WITH OWNER PRIOR TO

8.WHEREVER PIPES OF DIS-SIMILAR METALS ARE JOINED THE PIPING SYSTEMS SHALL BE PROTECTED AND ISOLATED BY USE OF DIELECTRIC UNIONS OR BRASS VALVES. 9.PROVIDE AND INSTALL UNION OR FLANGE CONNECTIONS AT ALL EQUIPMENT AND DEVICES TO ALLOW FOR EASE OF SERVICE OR FUTURE REPLACEMENT

10. PIPING SYSTEMS: CAST IRON AND COPPER OR PVC DWV. 1 SANITARY & STORM DRAINAGE ABOVE GROUND: CAST IRON AND COPPER OR PVC DWV TO ASTM E-84 2. SANITARY & STORM DRAINAGE IN PLENUM SPACE TYPE L COPPER WITH WROUGHT COPPER FITTINGS AND 3.DOMESTIC HOT & COLD WATER: LEAD FREE SOLDER. 4. SANITARY & STORM DRAINAGE

SCHEDULE 40 STEEL TYPE L COPPER 5.HEATING SYSTEMS:

6.DUCT HANGERS SHALL BE ROD OR STRAP 2 GAUGES HEAVIER THAN DUCT.

11. VALVES: 1.ISOLATE ALL SERVICEABLE EQUIPMENT, USING BALL AND BUTTERFLY VALVES WHERE POSSIBLE. 2.ALL VALVES SHALL HAVE A MINIMUM CERTIFIED RATING OF 150 PSI. 3.ALL DRAIN VALVES SHALL BE COMPLETE WITH CAP AND CHAIN. 4.INSTALL ¼ TURN BALL VALVES PRIOR TO ALL PRESSURE GAUGE DEVICES.

5.ALL GAS SYSTEM VALVES SHALL BE CSA APPROVED FOR APPLICATION. 6.PVC BALL VALVES, DOUBLE BACKING WITH UNION ENDS, SOLVENT WELD, PRESSURE RATED AT 230 PSI

1.ALL HANGERS SHALL BE OF SAME MATERIAL AS PIPING SYSTEM, OR SHALL BE ISOLATED FROM THE PIPE. 2 PROVIDE ADJUSTABLE CLEVIS HANGERS FOUAL TO PIPE SIZE AND OF SAME MATERIAL AS PIPING SYSTEM. 3.PROVIDE OVERSIZED HANGERS ON ALL COLD WATER PIPING CONVEYING LIQUID LESS THAN 21°C (70°F). 4.USE ONLY FACTORY MADE INSERTS, COACH SCREW RODS, C-CLAMPS, BEAM CLAMPS AND EXPANSION SHIELDS RATED FOR THE INTENDED LOAD. 5. "CADDY" CLIP OR TENSION CLIP ROD SUPPORTS ARE NOT ALLOWED ON THIS PROJECT.

13. PROVIDE AND INSTALL SLEEVES OF SUITABLE MATERIAL WHERE PIPING AND DUCT SYSTEMS PASS THROUGH ANY AND ALL SEPARATIONS 14. SUPPLY AND INSTALL THERMOSTATS AND GAUGES AT ALL MAJOR PIECES OF EQUIPMENT AND WHERE INDICATED ON THE DRAWINGS. (NOTE PSN-B SNUBBERS REQUIRED AT ALL GAUGES.) MOUNT ALL GAUGES AND THERMOSTATS VERTICALLY AND PLACE SO THAT EASE OF READING IS ENSURED.

PRESSURE AND TEMPERATURE RANGES SHALL BE SUITABLE FOR THE APPLICATION. 15. PRIMER PAINT ALL MISCELLANEOUS METAL SUPPORTS CHANNELS AND ANGLE IRON PRIOR TO INSTALLATION. 16. PIPE ALL WATER DISCHARGE FROM RELIEF VALVES AND EQUIPMENT DRAINS TO NEAREST FLOOR DRAIN OR SUITABLE RECEPTACLE. CONFIRM LOCATIONS WITH CONSULTANT PRIOR TO INSTALLATION.

PIPE ALL METHANOL AND GLYCOL DISCHARGE FROM RELIEF VALVES BACK TO FILL TANK 17. INSTALL ALL VALVES, STRAINERS, EQUIPMENT, SPECIALTIES, FILTERS AND THE LIKE TO PERMIT EASE OF OPERATION AND FULL ACCESS. 18. ACCEPTABLE JOINING SYSTEMS INCLUDE MECHANICAL JOINTS (SANITARY) SOLDERING, SILVER

SOLDERING, THREADED JOINTS, WELDING, GROOVED VICTAULIC (BLACK) AND GROOVED COPPER VICTAULIC. NOTE: TEE DRILLING AND PRESS-FIT SYSTEMS ARE NOT ACCEPTABLE ON THIS PROJECT 19. WHERE PASSING THROUGH ROOF STRUCTURES, ALL PIPING MUST EXTEND THROUGH THE SIDE OF PITCH BOXES. (EXCEPTION - PLUMBING VENTS) REFER TO ARCHITECTURAL DETAILS FOR CO-ORDINATION.

20. TEST ALL SYSTEMS TO 1½ TIMES WORKING PRESSURE FOR A MINIMUM OF TWO HOURS. ALL TESTS SHALL BE RECORDED AND INDEPENDENTLY WITNESSED. SUBMIT RECORDED DATA FOR CONSULTANT'S REVIEW PRIOR TO SUBSTANTICOMPLETION AND INCLUDE IN O&M MANUALS 21. PROVIDE AUTOMATIC AIR VENTS AT PIPING HIGH POINTS IN MECHANICAL SPACES, AND MANUAL AIR

22 07 10 INSULATION

VENTS AT ALL OTHER PIPING HIGH POINTS.

12 HANGERS AND SUPPORTS:

THE WORD "EXPOSED" WHERE USED IN THIS SECTION MEANS ANY WORK, WHICH IS NOT CONCEALED IN WALL, SHAFT, OR CEILING CAVITIES OR SPACES. WORK IN MECHANICAL ROOMS, UTILITY SPACES, BEHIND DOORS IN CLOSETS OR CUPBOARDS OR UNDER COUNTERS IS CONSIDERED EXPOSED.

1. R-24 FLEXIBLE BLANKET WITH FOIL JACKET, PIN AT 400MM ON CENTRE AND TAPE ALL JOINTS WITH

3. PRE-MOLDED PIPE INSULATION (PPI): PROVIDE ULC LISTED SECTIONAL FIBERGLASS PIPE INSULATION IN COMPLIANCE WITH ASTM C335-84 IN PRE-MOLDED SECTIONS 900MM (36") LONG. SPLIT AND READY FOR APPLICATION WITH A MINIMUM THERMAL CONDUCTIVITY OF 0.033 W/M DEG C AT 24°C (75°F) MEAN TEMPERATURE AND BE CAPABLE OF USE ON SERVICE FROM -40°C TO 260°C (-40°F TO 500°F) AND WITH FACTORY APPLIED VAPOUR SEAL JACKET OF VINYL COATED FOIL KRAFT LAMINATE WITH REINFORCING OF OPEN MESH GLASS FIBRE.

4. FINISHES & PROTECTIVE COVERINGS: CANVAS: 170 G/M2 WITH LAGGING ADHESIVE, ULC LABELED. TYVEK UNDER PROTECTIVE COVERING (ALUMINUM): 020 CHILDERS CORRUGATED ALUMINUM PRE-FORMED COVERING COMPLETE WITH STRAPPING AND SEALS. TROWELLED-ON WEATHER PROTECTIVE COATING: BAKOR 110-14 ASPHALT MASTIC VAPOLIR

APPLICATION SCHEDULE

BE TYPE 'C' FINISH.

38MM (1½") FOR LAST 3M (10') ALL FDI ** ALL EXPOSED INSULATED DUCTS IN MECHANICAL ROOM SERVICE ROOMS OR IN OCCUPIED SPACES ARE TO

BARRIER COATING P20 MIL PVC, HIGH IMPACT, UV RESISTANT, SOLVENT WELDED, RATED FOR

PIPING (PROVIDE CANVAS FINISH WHERE EXPOSED): 4. DOMESTIC COLD WATER 5. DOMESTIC HOT, RECIRCULATION ALL PPI 6. PLUMBING VENTS

** ALL EXPOSED INSULATED PIPING IN MECHANICAL ROOMS, SERVICE ROOMS OR VISIBLE IN OCCUPIED SPACES ARE TO BE TYPE 'C' OR 'P' FINISH

22 31 20 CHEMICAL TREATMENT 1. SANITIZING - DOMESTIC WATER: 1 POTABLE WATER SUPPLY SYSTEMS:

> THOROUGHLY FLUSH AND DISINFECT (CHLORINATE) WATER SUPPLY SYSTEMS IN ACCORDANCE WITH MUNICIPAL REQUIREMENTS AND AWWA C601-68. THE RATES OF CHLORINE APPLICATION TO BE PROPORTIONAL TO THE RATE OF WATER ENTERING THE PIPE. 2. FLUSH DOMESTIC WATER PIPING PRIOR TO INTRODUCING CHLORINE WITH A SUFFICIENT FLOW TO PRODUCE A VELOCITY OF 1 METRE PER SECOND FOR TEN MINUTES. OR UNTIL ALL FOREIGN MATERIALS HAVE BEEN REMOVED AND THE FLUSHED WATER IS CLEAR. PROVIDE CONNECTIONS AND PUMPS AS REQUIRED. 3. ARRANGE AND PAY FOR WATER QUALITY TESTS TO BE PERFORMED BY AN INDEPENDENT TESTING LABORATORY ACCEPTABLE TO THE CONSULTANT

1. LEAVE SYSTEMS OPERATING WITH WORK AREAS CLEAN TO ACCEPTANCE OF OWNER AND CONSULTANT.

22 08 10 TESTING AND BALANCING (TAB) 1. CONTRACTOR SHALL BE MEMBERS OF AABC.

COMPANY INFORMATION AND TESTING INFORMATION

2. BALANCE ALL SUPPLY AIR OUTLETS AND MAIN DUCTS CONVEYING 25% OR MORE OF SYSTEM VOLUME TO $\pm 5\%$ OF DESIGN. ALLOW TO REPLACE BELTS AND SHEAVES ON NEW AND EXISTING EQUIPMENT TO MEET AIR BALANCE VOLUMES. 3. BALANCE ALL AIR MOVING EQUIPMENT TO ±5%. 4. BALANCE ALL BRANCH DUCTWORK TO ±10%.

THE REPORTS TO CONTAIN RECORDED DATA AND SCHEMATICS AND BE FORMATTED AS PER AABC. 7. BALANCE ALL HEATING/COOLING SYSTEMS TO ±5%. 8. BALANCE ALL TERMINAL HEATING AND COOLING UNITS TO $\pm 10\%$. 9. ADJUST CIRCUIT BALANCING VALVE SET SCREW TO FINAL POSITION

5. TEST ALL FIRE DAMPERS, STOPS AND FLAPS TO INDUSTRY STANDARDS. TAG EACH DEVICE LISTING

10.ADVISE VENTILATION CONTRACTOR WHERE BALANCING DAMPERS ARE REQUIRED TO FACILITATE BALANCING OF VENTILATION SYSTEM. 11.ADVISE HVAC CONTRACTOR WHERE CIRCUIT BALANCING VALVES ARE REQUIRED TO FACILITATE BALANCING OF HEATING AND COOLING SYSTEMS.

2.ARRANGE WITH MECHANICAL CONTRACTOR TO HAVE ANY NECESSARY MODIFICATIONS TO ACHIEVE THE DESIGN AND FLOW RATES AT NO EXTRA COST TO OWNER. 13.THREE (3) COPIES OF THE TAB REPORT, INCLUDING CERTIFICATION OF FIRE DAMPERS, STOPS AND FLAPS SHALL BE PROVIDED DIRECTLY TO THE CONSULTANT PRIOR TO CERTIFICATION FOR OCCUPANCY

INCLUDE DRAWINGS, ROOM NUMBERS AND IDENTIFICATION NUMBERS OF FIRE DAMPERS, TYPES, AND FLAPS ON THE SCHEMATICS. 14. TAB REPORT SHALL INCLUDE FINAL VALVE POSITION FOR ALL CIRCUIT BALANCING VALVES. 15.TAB REPORT SHALL INCLUDE SCHEMATIC DRAWINGS IDENTIFYING ALL FIRE DAMPERS AND CIRCUIT

BALANCING VALVE LOCATIONS. 16. TAB REPORT SHALL INCLUDE PUMP CURVES ON ALL BALANCED PUMPS. 17.ALLOW FOR AN ADDITIONAL SITE REVIEW AND ADJUSTMENTS AT THE REQUEST OF THE CONSULTANT AFTER SUBMISSION OF FINAL REPORT

22 10 05 PLUMBING

. SUPPLY AND INSTALL FIXTURES INDICATED UNDER CONTRACT DOCUMENTS TO PROVIDE A COMPLETE AND FUNCTIONAL PLUMBING SYSTEM.

2. LISE ONLY LEAD ERFE SOLDERS WHEN JOINING PIPING COMPONENTS. 3. PROVIDE ACCESS DOORS AT ALL CONCEALED CLEANOUTS, VALVES AND WATER HAMMER ARRESTORS 4. INSTALL WATER HAMMER ARRESTORS AT EACH GROUP OF FIXTURES. 5. INSTALL TRAP PRIMERS AS INDICATED ON THE CONTRACT DOCUMENTS AND AS REQUIRED BY LOCAL

CODE AUTHORITIES. 6. INSTALL DEEP SEAL TRAPPED CONDENSATE DRAINS FROM ALL COOLING EQUIPMENT. 7. FIXTURES SHALL BE WHITE AND COMPLETE WITH CHROME TRIM, FIXTURE STOPS SHALL BE SCREWDRIVER TYPE WHERE EXPOSED. WHEEL HANDLE WHERE CONCEALED.

8. WATER CLOSET MAP TEST MINIMUM: 800 GRAMS 9. WATER CLOSETS BALL PASS TEST: 2 1/8 (54MM) GLAZED, MINIMUM.

21 00 10 FIRE PROTECTION . PROVIDE PORTABLE FIRE EXTINGUISHERS; AS INDICATED ON DRAWINGS, WHERE NONE ARE INDICATED REFER TO NFPA 10 FOR TYPE AND LOCATION.

23 30 10 VENTILATION

SUPPLY AND INSTALL A COMPLETE VENTILATION SYSTEM AS INDICATED ON THE DRAWINGS AND AS REQUIRED BY LOCAL CODES AND AUTHORITIES. DO ALL WORK TO LATEST SMACNA STANDARDS FOR

APPLICABLE DUCT VELOCITY. 2. SYSTEM SHALL INCLUDE ALL DUCTS, FIRE DAMPERS, TRANSFER AIR OPENINGS, FANS, BALANCE DAMPERS, GRILLES, DIFFUSERS AND HOODS INDICATED ON DRAWINGS AND AS REQUIRED BY CODE 3. PROVIDE ACCESS DOORS TO COMPLY WITH CODE ON BOTH SIDES OF FIRE DAMPERS, CONTROL

DAMPERS AND ALL COILS. ACCESS DOORS SHALL BE CONSTRUCTED OF 22-GAUGE MATERIAL WITH FLAT IRON FRAMING COMPLETE WITH SASH LOCK LATCHING AND SEAL. 4. PROVIDE 1" THICK ACOUSTIC INSULATION WHERE INDICATED ON DRAWINGS. MINIMUM 3-5 LBS PER CUBIC FOOT DENSITY WITH NEOPRENE COATING. SEAL ALL JOINTS AND SEAMS.

5. PROVIDE ULC LABELLED FIRE DAMPERS AND FLAPS WHERE INDICATED ON DRAWINGS AND AT ALL RATED SEPARATIONS, PROTECT CEILING DIFFUSERS WITH CK 2000 THERMAL BLANKET. 6. PROVIDE LOCKING SPLITTER AND QUADRANT DAMPERS AS INDICATED ON DRAWINGS OR AS NECESSARY TO BALANCE SYSTEM AND REDUCE OBJECTIONABLE NOISE. 7. PROTECT AND KEEP CLOSED OPEN ENDS OF DUCT SYSTEMS WHILE UNDER CONSTRUCTION TO PREVENT

8. PROVIDE BAFFLES TO REDUCE OBJECTIONABLE NOISE AS DIRECTED BY THE CONSULTANT AT NO ADDITIONAL COST. 9 SEALALL JOINTS IN SUPPLY OUTSIDE AND EXHAUST DUCT SYSTEMS WITH APPROVED WATER BASED SEALANT INCLUDING ALL LONGITUDINAL AND VERTICAL SEAMS ON EXPOSED DUCTS. TAPE BOTH SIDES OF EACH SEAM PRIOR TO SEALING AND REMOVE TAPE AFTER SEALANT DRIES FOR AN EVEN. UNIFORM

10.CEILING MOUNTED COMPONENTS SHALL BE INSTALLED IN ACCORDANCE WITH ARCHITECTURAL REFLECTED CEILING PLAN. COORDINATE WITH ALL CEILING MOUNTED EQUIPMENT

25 09 10 CONTROLS

DUST AND DEBRIS PENETRATION.

1. ALL CONTROLS SHALL BE SUPPLIED BY THIS SECTION. PROVIDE ALL WIRING DIAGRAMS FOR LINE VOLTAGE WIRING BY DIVISION 26 ELECTRICAL CONTRACTOR, COORDINATE ALL REQUIREMENTS OF DIVISION 26 WITH ELECTRICAL CONTRACTOR PRIOR TO SUBMITTING BID.

2. PROVIDE ALL CONTROL VALVES FOR INSTALLATION BY HEATING CONTRACTOR 23 00 10.

3. SYSTEM SHALL BE COMPLETE WITH ALL NECESSARY WIRING, INTERLOCKS, DEVICES AND SOFTWARE NECESSARY TO ENSURE A COMPLETE AND OPERATIONAL SYSTEM. 4. SET, OPERATE AND CO-ORDINATE ALL DEVICES FOR FULLY FUNCTIONAL SYSTEM ALL WIRING TO MEET DIVISION 27 SPECIFICATION REQUIREMENTS. 6. PROVIDE A DDC CONTROL WITH ALL THERMOSTATS, CONTROLLERS, DAMPERS, VALVES, OPERATORS,

SWITCHES AND OTHER ACCESSORY EQUIPMENT IN ACCORDANCE WITH THE DRAWINGS WHICH

1. FAN POWERED TERMINAL UNITS: CURRENT CONTROL SYSTEM IS: JOHNSON CONTROLS - METASYS ENTENDED ARCHITECTURE.

THIS IS THE ONLY ACCEPTABLE PRODUCT. USE OPERATOR WORKSTATION SOFTWARE, CONTROLLER SOFTWARE, CUSTOM APPLICATION PROGRAMMING LANGUAGE AND CONTROLLERS ONLY FROM THIS MANUFACTURER.

MODIFY EXISTING GRAPHICS AND CONTROL POINTS TO MATCH NEW.

7. SEQUENCE OF OPERATIONS.

SHALL INCLUDE BUT NOT BE LIMITED TO:

EXISTING FAN POWERED TERMINAL BOXES: GENERAL: THESE UNITS PROVIDE VENTILATION, HEATING AND COOLING.

> RUN CONDITIONS: THE SYSTEM SHALL RUN CONTINUOUSLY DURING OCCUPIED HOURS (AS PROGRAMMED BY THE BUILDING OPERATOR) AND SHALL MAINTAIN A SUPPLY AIR SETPOINT OF 18C (ADJ.) THE SYSTEM SHALL BE OFF DURING UNOCCUPIED PERIODS (AS PROGRAMMED BY THE BUILDING OPERATOR) UNLESS STARTED BY THE UNOCCUPIED CYCLE PROGRAM. THE SYSTEM MAY ALSO BE RETURNED TO THE OCCUPIED STATUS BY SELECTING THE TEMPORARY OVERRIDE FUNCTION ON THE OPERATOR WORKSTATION (OWS). STATUS: FAN OPERATION.

> > **END OF SECTION**



2017.08.21 Issued for Tender 2017.07.14 Issued for Client Review REVISION DESCRIPTION DATE SEALS:

THIS DRAWING MUST NOT BE SCALED. THE GENERAL CONTRACTOR SHALL VERIFY ALL DIMENSIONS, DATA AND LEVELS PRIOR TO COMMENCEMENT OF WORK. ALL ERRORS AND OMISSIONS TO BE REPORTED TO MCW/AGE CONSULTING PROFESSIONAL ENGINEERS BEFORE PROCEEDING

THIS DRAWING IS NOT TO BE USED FOR CONSTRUCTION

WITHOUT A PROFESSIONAL SIGNATURE THROUGH THE SEAL

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210-1821 Wellington Ave Winnipeg, Manitoba, R3H 0G4 Phone - (204) 779-7900 Fax - (204) 779-1119

PROJECT NAME:

CBRE - LU Chancellor Paterson Library

Teachers Common Renovations

SHEET TITLE:

MECHANICAL

DATE: 08/21/17

CCT.	OLD OUT LIGH	BRE	BREAKER			VA		WIRE AND CONDUIT
No.	CIRCUIT USE	SIZE	POLES	VOLTS	PHASE A	PHASE B	PHASE C	SIZE
P-1	SYSTEM FURNITURE RECEPTACLES - ROOM 5003	15A	1	120V	1080			2c#12 AWG IN EMT
P-2	SYSTEM FURNITURE RECEPTACLES - ROOM 5003	15A	1	120V		1080		2c#12 AWG IN EMT
P-3	SYSTEM FURNITURE RECEPTACLES - ROOM 5003	15A	1	120V			480	2c#12 AWG IN EMT
P-4	DATA RECEPTACLES - ROOM 5003H, 5003J	15A	1	120V	900			2c#12 AWG IN EMT
P-5	DATA RECEPTACLES - ROOM 5003	15A	1	120V		900		2c#12 AWG IN EMT
P-6	RECEPTACLES W/ USB - ROOM 5003	15A	1	120V			600	2c#12 AWG IN EMT
P-7	DATA RECEPTACLES - ROOMS 5003E, 5003F	15A	1	120V	720			2c#12 AWG IN EMT
P-8	DATA RECEPTACLES - ROOMS 5003A, 5003B	15A	1	120V		720		2c#12 AWG IN EMT
P-9	DATA RECEPTACLES - ROOMS 5003K, 5003L	15A	1	120V			720	2c#12 AWG IN EMT
P-10	DATA RECEPTACLES - ROOM 5003D	15A	1	120V	720			2c#12 AWG IN EMT
P-11	DATA RECEPTACLES - ROOM 5005, 5005a	15A	1	120V		720		2c#12 AWG IN EMT
P-12	GENERAL RECEPTACLES	15A	1	120V			960	2c#12 AWG IN EMT
P-13	20A GFI RECEPTACLE	20A	1	120V	750			2c#12 AWG IN EMT
P-14	DATA RECEPTACLES - ROOM 5003	15A	1	120V		360		2c#12 AWG IN EMT
P-15	DATA RECEPTACLES - ROOMS 5003C, 5003D	15A	1	120V			720	2c#12 AWG IN EMT
P-16	DATA / MEDIA RECEPTACLES - ROOM 5003H	15A	1	120V	720			2c#12 AWG IN EMT
P-17	DATA / MEDIA RECEPTACLES - ROOM 5002	15A	1	120V		720		2c#12 AWG IN EMT
P-18	DATA / MEDIA RECEPTACLES - ROOM 5002	15A	1	120V			540	2c#12 AWG IN EMT

	NEW LIGHTING CIRCUITS								
CCT.	OIDOUIT LICE		BREAKER		VA			WIRE AND CONDUIT	
No.	CIRCUIT USE	SIZE	POLES	VOLTS	PHASE A	PHASE B	PHASE C	SIZE	
L-1	NEW LIGHTING	15A	1	120V	820			2c#12 AWG IN EMT	
L-2	NEW LIGHTING	15A	1	120V		630		2c#12 AWG IN EMT	
L-3	NEW LIGHTING	15A	1	120V			880	2c#12 AWG IN EMT	
L-3 NEW LIGHTING 15A 1 120V 880 2 - RE-USE EXISTING CIRCUITS, GROUP THE FIXTURES/DEVICES AS SHOWN IN THIS SCHEDULE, ADD NEW BREAKERS AS REQUIRED.								2C#12 AWG IN E	

- UTILIZE SPACE IN PANEL '00' PRIOR TO ADDING NEW CIRCUITS INTO PANEL 'LL', PANEL 'JJ', PANEL 'KK'.

- FEED FROM PANEL 'LL', PANEL 'JJ', PANEL 'KK'

GENERAL SPECIFICATIONS

- 1. INSTALLATION SHALL BE IN ACCORDANCE WITH THE ONTARIO HYDRO ELECTRICAL SAFETY CODE LATEST EDITION & ALL OTHER APPLICABLE CODES & REGULATIONS.
- 2. ALL EQUIPMENT SHALL BE NEW AND CSA CERTIFIED.
- 3. ELECTRICAL CONTRACTOR SHALL SUPPLY EQUIPMENT AS SPECIFIED AS WELL AS ANY MISCELLANEOUS TO COMPLETE THE WORK.
- 4. IDENTIFY ELECTRICAL EQUIPMENT WITH PROPER NAMEPLATES. IDENTIFY ALL WIRING, MAINTAIN PHASE SEQUENCE & COLOUR CODING.
- 5. CONTRACTOR TO FURNISH CERTIFICATES OF ACCEPTANCE FROM THE ELECTRICAL INSPECTION DEPARTMENT UPON COMPLETION OF WORK TO THE
- ENGINEER. REVERIFY F/A SYSTEM BY QUALIFIED PERSONNEL. 6. ALL WIRING SHALL BE MIN. #12 AWG Cu. IN EMT (UNLESS OTHERWISE
- NOTED). 7. INSTALL INSULATED GREEN BONDING CONDUCTOR IN ALL EMT CONDUIT.
- 8. ALL WIRING SHALL BE CONCEALED FROM VIEW UNLESS OTHERWISE
- 9. ELECTRICAL CONTRACTOR SHALL MAKE A PERSONAL SITE VISIT AND CONFIRM ALL QUANTITIES/LOCATION/MOUNTING PRIOR TO SUBMITTING
- 10. CONTRACTOR SHALL REPAIR ALL SURFACES DAMAGED DUE TO WORK PERFORMED.
- 11. CONTRACTOR SHALL VERIFY ALL DIMENSIONS, DO NOT SCALE DRAWING.
- 12. ALL MATERIALS REMOVED AND MADE REDUNDANT BY THIS WORK (UNLESS INDICATED OTHERWISE) SHALL BECOME PROPERTY OF OWNER.
- 13. MOUNTING HEIGHTS FOR DEVICES AS PER CODE REQUIREMENTS, UNLESS OTHERWISE NOTED.
- 14. COORDINATE COLOUR FOR ALL WALL PLATES, RECEPTACLES, SWITCHES AND DEVICES WITH OWNER. NEW WIRING DEVICES SHALL BE COMMERICAL GRADE. COVER PLATES TO BE PREMIUM GRADE STAINLESS STEEL. LABEL RECEPTACLE WITH THEIR RESPECTIVE CIRCUIT AND PANEL USING CLEAR P-TOUCH LABELS WITH BLACK LETTERING.
- 15. COORDINATE ALL LIGHT FIXTURE AND RECEPTACLE INSTALLATION IN MILLWORK WITH CABINET BUILDER.
- 16. TIE EXIT SIGNS INTO EXISTING EXIT SIGN CIRCUIT.
- 17. THE INTENT OF THIS PROJECT IS INSTALL A COMPLETE LIGHTING DESIGN. IF SWITCHING FOR AN AREA IS NOT SHOWN, THE ELECTRICAL CONTRACTOR SHALL PROVIDE SWITCHING.
- 18. COMPLETE TYPEWRITTEN PANEL SCHEDULES ARE TO BE PROVIDED FOR ALL PANELS AFFECTED BY WORK. ALL LOADS FED FROM RELOCATED EXISTING CIRCUITS ARE TO BE DETERMINED AND INCLUDED IN PANEL SCHEDULES.
- 19. ALL CEILING SPACES IN RENOVATION AREAS ACT AS RETURN AIR PLENUMS. ALL CABLING IN CEILING SPACE MUST HAVE AN FT6 FIRE RATING OR BE COMPLETELY ENCLOSED IN CONDUIT.

GENERAL DEMOLITION NOTES

- 1. REMOVE ALL UNNECESSARY EXISTING ELECTRICAL EQUIPMENT. WIRING. & FIXTURES IN THOSE PORTIONS OF THE EXISTING BUILDING WHICH ARE BEING REMODELED OR DEMOLISHED. THE ELECTRICAL CONTRACTOR SHALL REMOVE ALL REDUNDANT EQUIPMENT FROM SITE. ANY ELECTRICAL EQUIPMENT IN REMODELED SECTIONS OR IN STRUCTURES REMOVED OR ALTERED, ADJACENT TO NEW WORK, NECESSARY FOR THE OPERATION OF EXISTING BUILDING, SHALL BE RELOCATED AS NECESSARY. ALL EXISTING EQUIPMENT REUSED SHALL BE MADE GOOD AND GUARANTEED. REVISE PANEL SCHEDULES TO SUIT.
- 2. ALL REDUNDANT EQUIPMENT MAY NOT APPEAR IN DRAWING SET. IT IS THE RESPONSIBILITY OF THE ELECTRICAL CONTRACTOR TO REMOVE ALL REDUNDANT EQUIPMENT AND ADHERE TO DEMOLITION NOTE #1 IN ALL
- 3. REFER TO ARCHITECTURAL DEMOLITION DRAWINGS AND NOTES AND COORDINATE AS REQUIRED.

POWER/SYSTEMS IDENTIFICATION LEGEND

DUPLEX RECEPTACLE

DUPLEX RECEPTACLE W/ USB CHARGING OUTLETS

QUAD RECEPTACLE

GFI RECEPTACLE

20A GFI RECEPTACLE

NEW COMMUNICATIONS OUTLET C/W DOUBLE GANG BOX & SINGLE GANG REDUCING PLATE AND 3/4" EMT CONDUIT TO ACCESSIBLE CEILING SPACE. PROVIDE INDICATED NUMBER OF CAT6 DATA CABLES FROM EACH OUTLET BACK TO 5th FLOOR I.T. ROOM. LEAVE 3m OF SLACK NEATLY COILED IN CEILING SPACE AT EACH END. FINAL TERMINATION BY OWNER. '#D' DENOTES NUMBER OF DATA CABLES RUN TO LOCATION. DATA CABLE SPECIFICATION (no substitutes) - Belden 2413 series Cat 6-Plenum (white in colour)

EXISTING VOICE/DATA OUTLET

V EXISTING TELEPHONE OUTLET

FIRE ALARM PULLSTATION

FIRE ALARM BELL

FIRE ALARM HEAT DETECTOR

FIRE ALARM SMOKE DETECTOR

FB' DENOTES DEVICES IN FLOOR BOX.

MULTI-DEVICE, FLUSH-MOUNT FLOOR BOX C/W HINGED TOP AND DEVICES AS NOTED ON DRAWINGS. FLOOR BOX TOP TO BE COMPLETE WITH OPENINGS TO ALLOW CABLES (POWER CORDS & DATA PATCH CORDS) TO EXIT WITHOUT OPENING COVER. PROVIDE TOP AND FLANGE APPROPRIATE FOR FLOORING TYPE. BLACK FINISH. SUBMIT SHOP DRAWINGS.

'ME' DENOTES DEVICES FOR MULTIMEDIA EQUIPMENT AT A HIGH LEVEL, REFER TO ARCHITECTURAL ELEVATIONS FOR EXACT MOUNTING HEIGHTS.

SF 'SF' DENOTES DEVICES LOCATED IN SYSTEM FURNITURE. REFER TO MANUFACTURER'S LITERATURE. COORDINATE WITH FURNITURE INSTALLER.

AV 'AV' DENOTES DEVICES FOR AUDIO/VISUAL EQUIPMENT TO BE MOUNTED AT HIGH LEVEL, NEAR CEILING.

WA 'WA' DENOTES DEVICES FOR WIRELESS ACCESS POINT TO BE MOUNTED IN CEILING SPACE.

'CH' DENOTES DEVICE WALL-MOUNTED AT COUNTER

'EX' DENOTES EXISTING DEVICE TO BE REMOVED AND REPLACED WITH NEW.

RP 'RP' DENOTES EXISTING DEVICE TO BE REPLACED WITH NEW.

'RM' DENOTES EXISTING DEVICE TO BE REMOVED C/W ALL WIRING TO SOURCE. MAINTAIN CIRCUIT INTEGRITY.

'RL' DENOTES DEVICE TO BE REMOVED AND REUSED IN NEW LOCATION. EXTEND WIRING AND CONDUIT AS REQUIRED. REFER TO DEMOLITION PLANS, RENOVATION PLANS, GENERAL ELECTRICAL CONSTRUCTION NOTES AND SPECIFICATIONS.

LIGHTING IDENTIFICATION LEGEND

TYPE 'T1' - LED TROFFER FIXTURE - 1220 x 305 35W, 120V, 3500°K, 4100 LUMEN C/W DIFFUSE LENS,0-10V DIMMING DRIVER, PHILIPS DAY-BRITE DUALED SERIES CAT# 1-DL-G-41L-835-4-D-UNV-DIM

> TYPE 'T2' - LED TROFFER FIXTURE - 1220 x 610 35W, 120V, 3500°K, 4300 LUMEN C/W DIFFUSE LENS,0-10V DIMMING DRIVER, PHILIPS DAY-BRITE DUALED SERIES

> > CAT# 2905-L-B-C-Q-Q-04-1-1-E-W

CAT# 2-DL-G-43L-835-4-D-UNV-DIM <u>TYPE 'P1'</u> - LED UP/DOWN PENDANT FIXTURE - 1220 x 82 47W, 120V, 3500°K, 4600 LUMEN C/W 0-10V DIMMING DRIVER

PHILIPS LEDALITE TruGROOVE SUSPENDED SERIES

TYPE 'D1' - LED 4" DOWNLIGHT FIXTURE $D1 \Sigma$ 20W, 120V, 3500°K, 1000 LUMEN C/W 0-10V DIMMING, CLEAR REFLECTOR, WHITE FLANGE PHILIPS LIGHTOLIER CALCULITE SERIES FRAME-IN CAT# C4-R-N ENGINE CAT# C4L-10-8-35-M-Z10-U

TOGGLE SWITCH,

THREE-WAY TOGGLE SWITCH

TRIM KIT CAT# C4-R-DL-CL

LED "RUNNING MAN" EXIT SIGN W/ PICTOGRAM SYMBOLS CONFORMING TO ISO 7010. EXTRUDED ALUMINUM FRAME W/ CLEAR POLYCARBONATE PANELS AND PICTOGRAM FILMS. SELF-POWERED WITH NICKLE-CADMIUM BATTERY SIZED FOR 2 HOURS BACKUP. UNIVERSAL VOLTAGE (120V-347V). SINGLE OR DOUBLE FACED TO SUIT AND PICTOGRAM FILMS TO DENOTE EXIT DIRECTIONS AS NOTED ON DRAWINGS. EMERGI-LITE# EA SERIES

'NL' DENOTES AN UNSWITCHED NIGHT LIGHT FIXTURE

'EM' DENOTES A LIGHT FIXTURE FED FROM EXISTING EMERGENCY LIGHTING CIRCUIT.

TYPE 'X1' - EXISTING FLUORESCENT TROFFER FIXTURE

TYPE 'X2' - EXISTING FLUORESCENT TROFFER FIXTURE 2 LAMP, 2'x4'


TYPE 'X3' - EXISTING FLUORESCENT TROFFER FIXTURE

TYPE 'X4' - EXISTING RECESSED ROUND DOWNLIGHT

EXISTING EXIT SIGN TO BE REMOVED

EXISTING FIXTURE TO BE REMOVED

EXISTING FIXTURE TO BE REMAIN

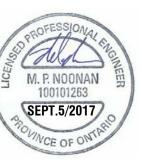

REVISED DATA LAYOUT ISSUED FOR PERMIT DESCRIPTION Electrical Engineers Fax: (807) 622-3633

GAP | SEPT 5/2017


| GAP | AUG 22/2017


BY DATE

Lakehead University - Chancellor Peterson Library **Fifth Floor - Teacher's Commons Renovations** 955 Oliver Road, Thunder Bay, ON DRAWING TITLE

Identification Legends & Specifications

DWG SCALE: As indicated PLOT SCALE: 1:1 DATE ISSUED: Sept 2017 DRAWN BY: GAP PROJECT No. A101-17-006 | APPROVED BY: MPN DWG No. REV.

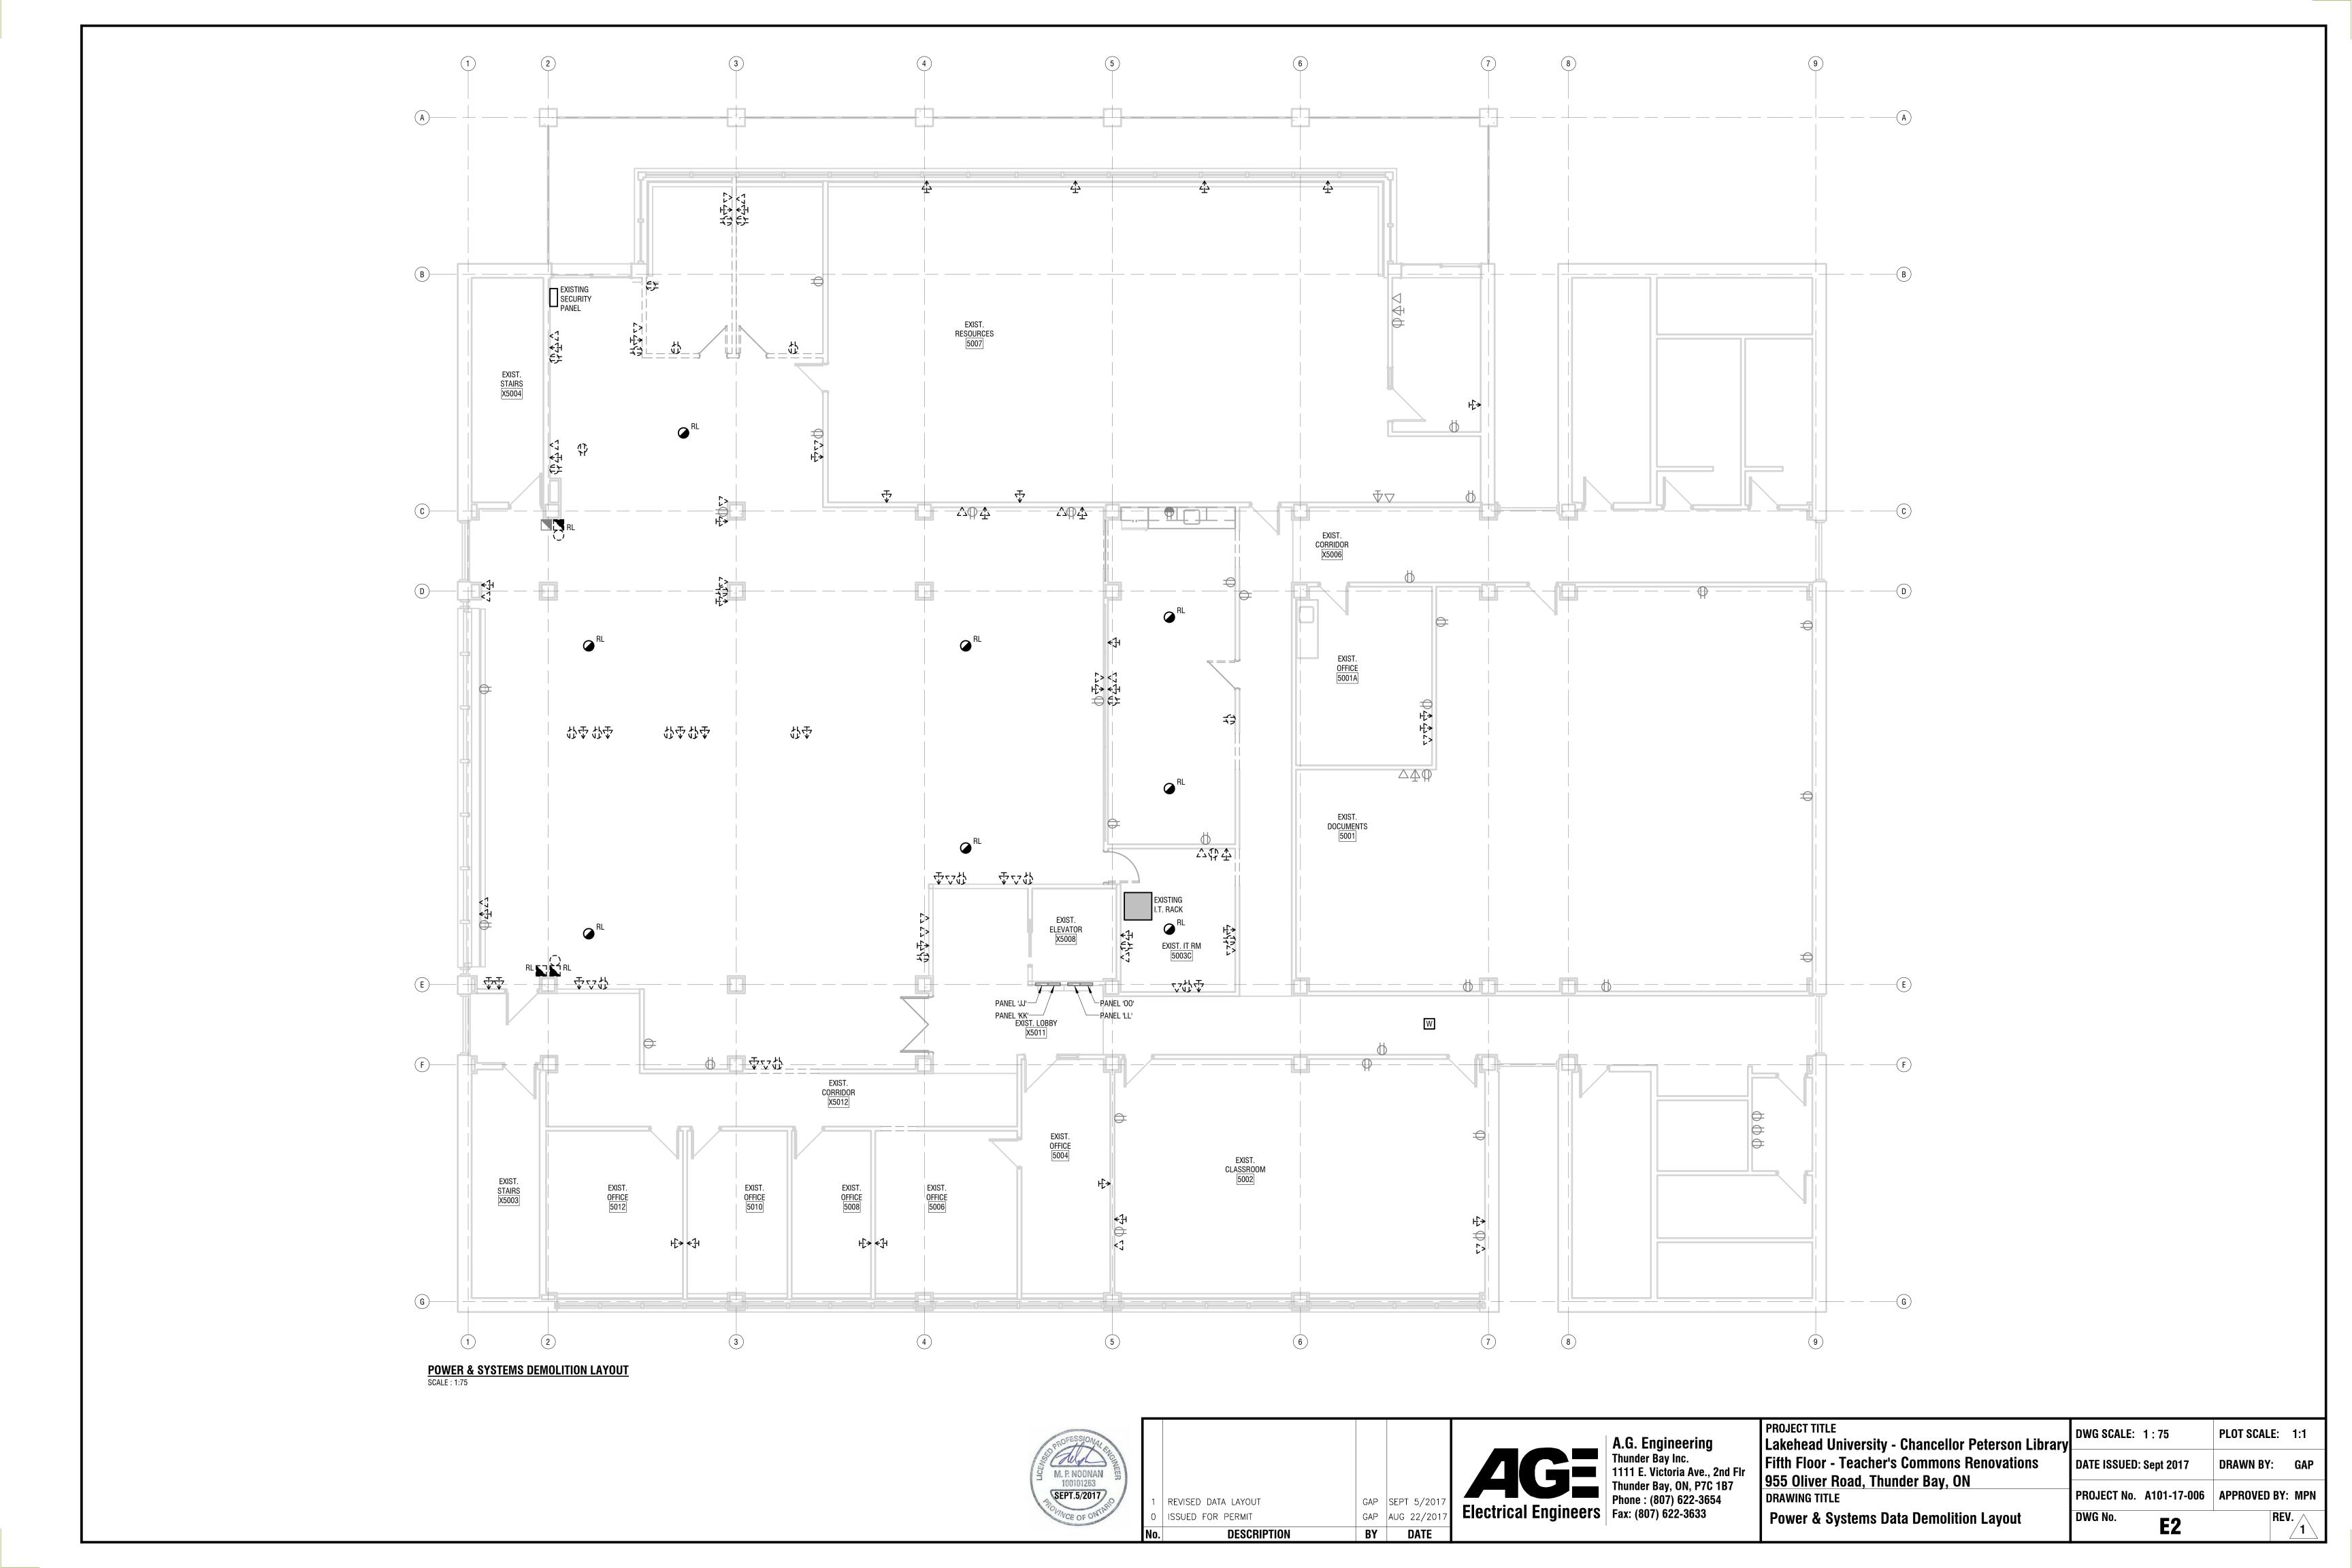

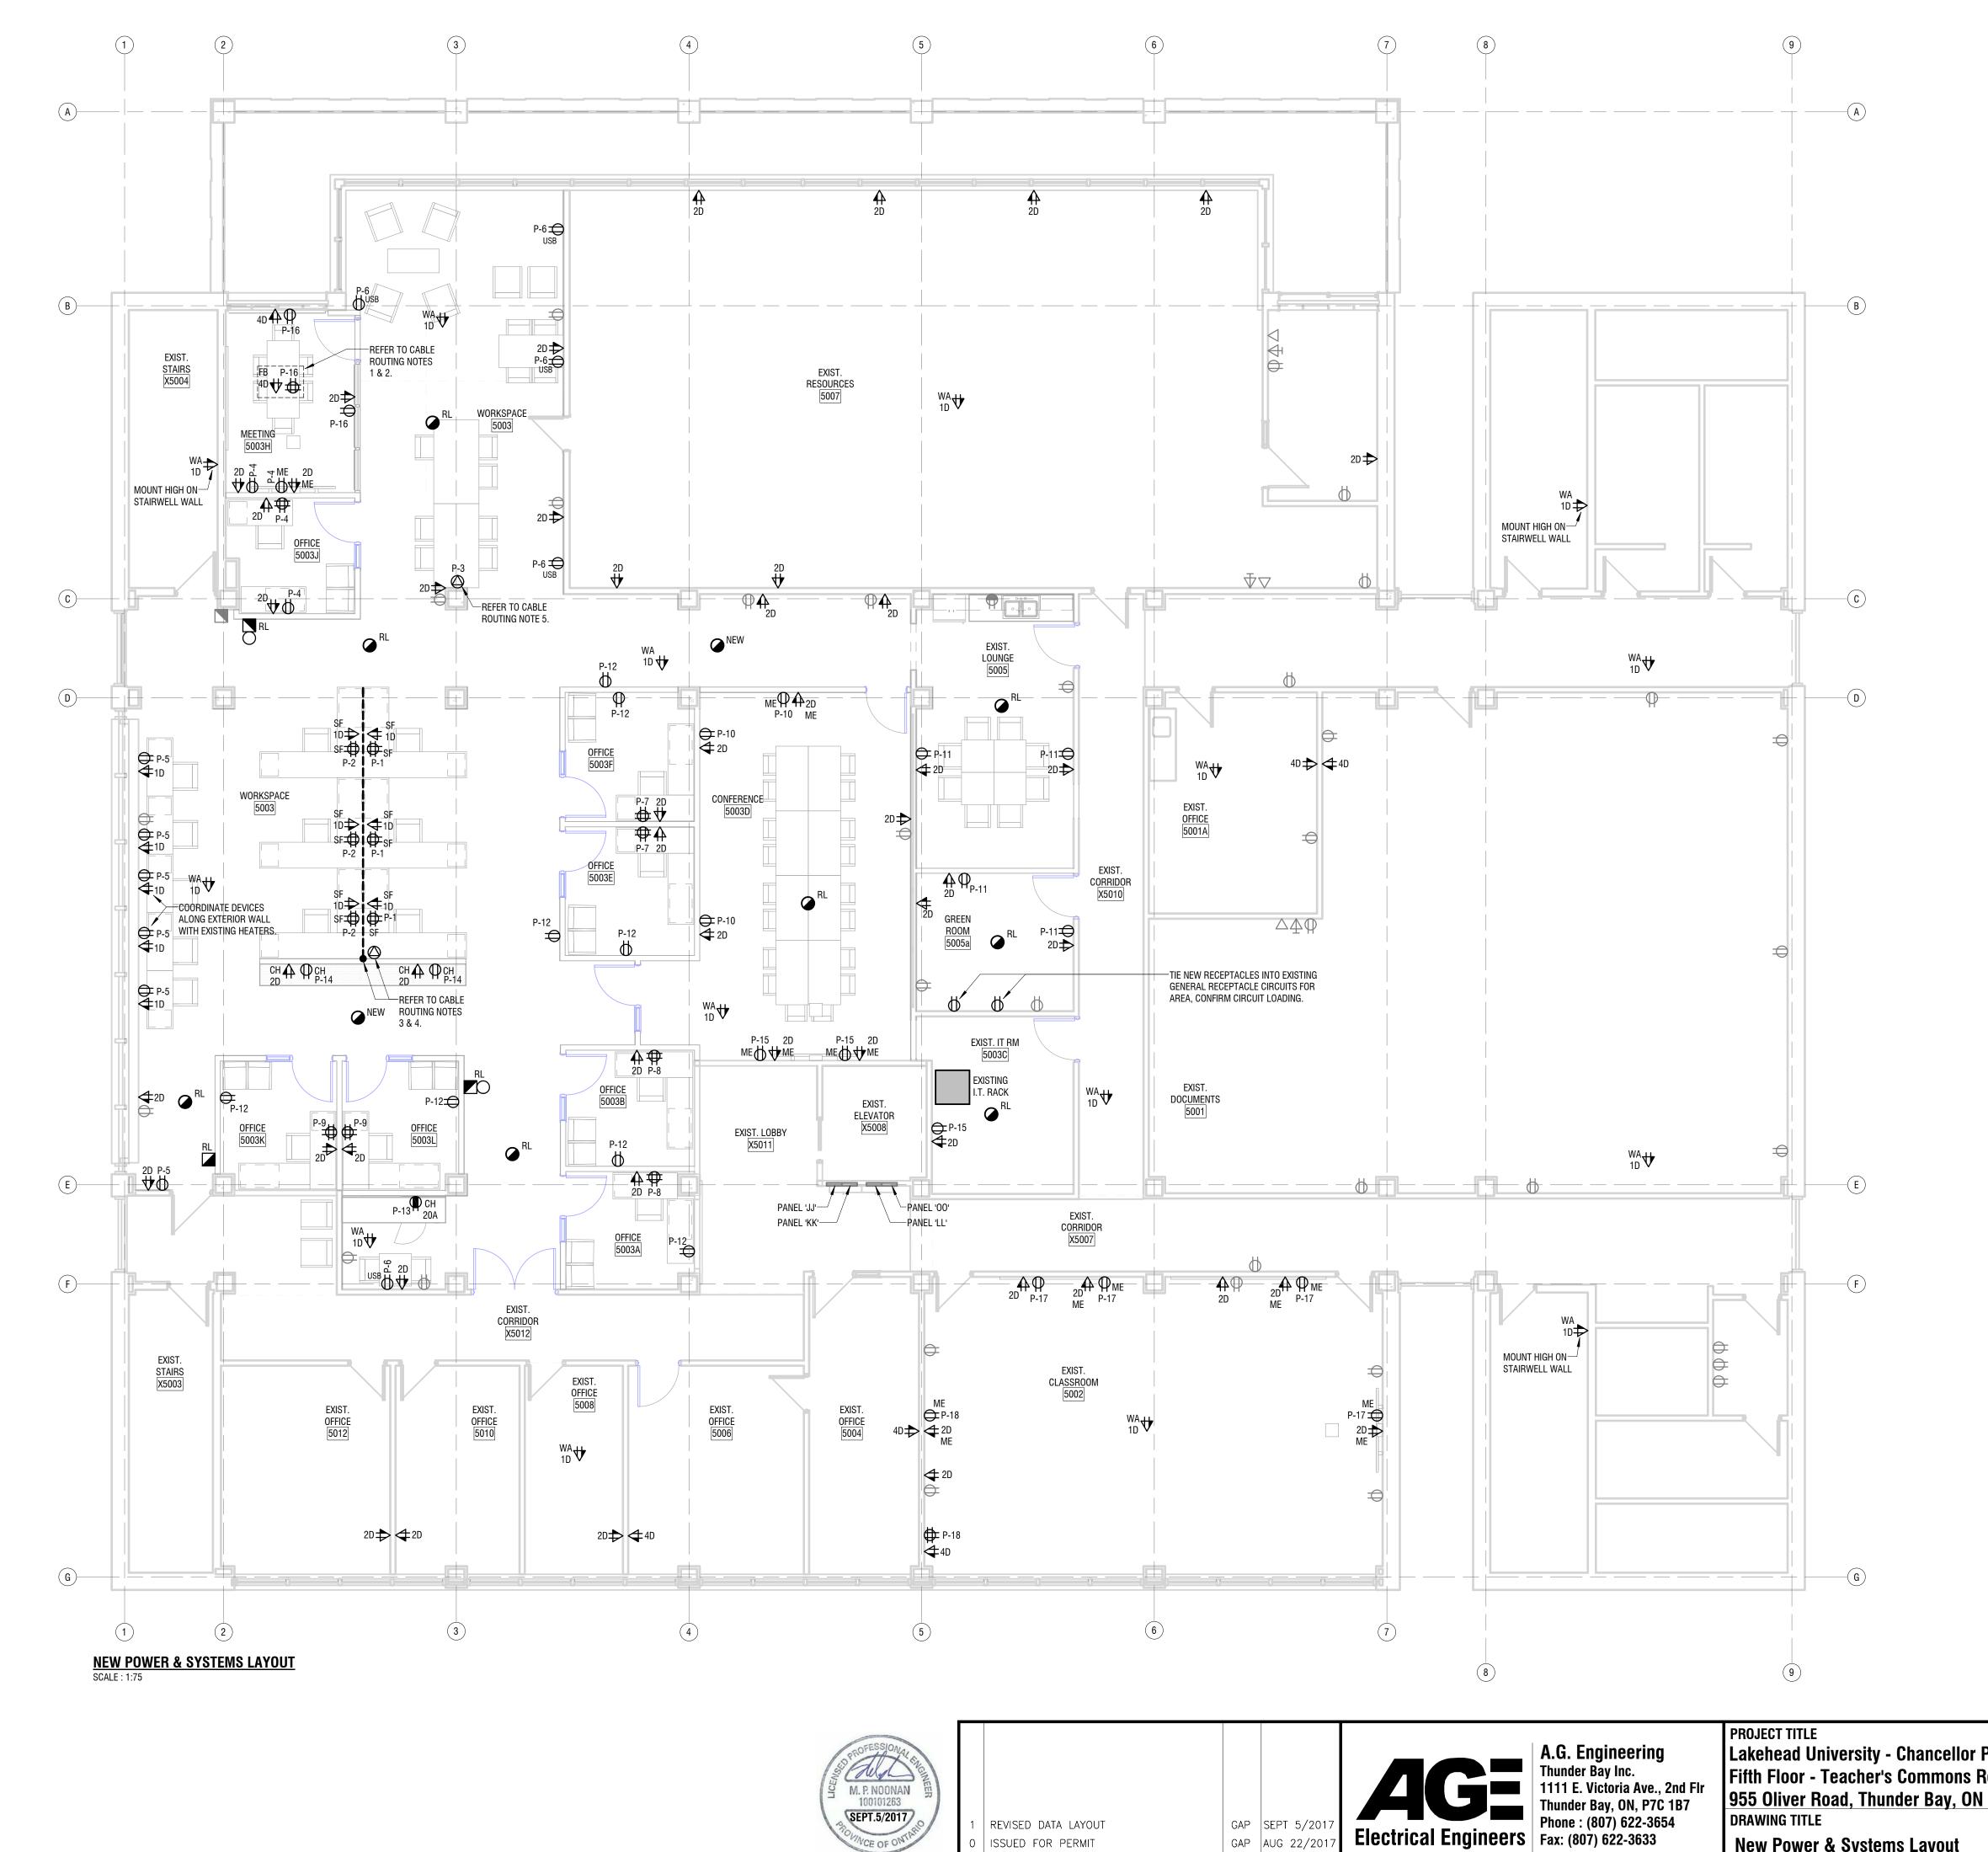

BY DATE

DESCRIPTION

CABLE ROUTING NOTES

- 1. POWER AND DATA CABLING FOR MEETING ROOM 5003H FLOOR BOX TO BE ROUTED FROM PANELS AND LAN ROOM VIA FOURTH FLOOR CEILING SPACE. PROVIDE CONDUIT AND JUNCTION BOXES AS REQUIRED. ALL WORK ON FOURTH FLOOR TO BE DONE IN OFF HOURS, REFER TO ARCHITECTURAL SPECIFICATIONS. PROVIDE PROPER FIRE STOPPING FOR ALL FLOOR PENETRATIONS.
- 2. COORDINATE EXACT LOCATION OF MEETING ROOM 5003H FLOOR BOX WITH FURNITURE INSTALLER AND ARCHITECTURAL TRADES TO ENSURE FLOOR BOX IS PROPERLY LOCATED TO ACCESS THE MEETING TABLE RACEWAY.
- 3. POWER AND DATA CABLING TO HALF-HEIGHT WALL FOR CONNECITON TO DEVICES AND SYSTEMS FURNITURE TO BE ROUTED FROM PANELS AND LAN ROOM VIA FOURTH FLOOR CEILING SPACE. PROVIDE CONDUIT AND JUNCTION BOXES AS REQUIRED. ALL WORK ON FOURTH FLOOR TO BE DONE IN OFF HOURS, REFER TO ARCHITECTURAL SPECIFICATIONS. HALF-HEIGHT WALL IS NARROW, AND CAN ONLY ALLOW FOR A MAXIMUM 3" DIAMETER HOLE FROM FOURTH FLOOR. COORDINATE EXACT LOCATION OF FLOOR PENETRATIONS WITH ARCHTECTURAL. PROVIDE PROPER FIRE STOPPING FOR ALL FLOOR PENETRATIONS.
- 4. WHIP CONNECTION TO SYSTEM FURNITURE FROM HALF-HEIGHT WALL. FIELD LOCATE JUNCTION BOX. REFER TO MANUFACTURER'S LITERATURE, COORDINATE WITH SYSTEM FURNITURE INSTALLER.
- 5. WHIP CONNECTION TO SYSTEM FURNITURE FROM COLUMN, FIELD LOCATE JUNCTION BOX. REFER TO MANUFACTURER'S LITERATURE, COORDINATE WITH SYSTEM FURNITURE INSTALLER.

PROJECT TITLE
Lakehead University - Chancellor Peterson Library
Fifth Floor - Teacher's Commons Renovations
955 Oliver Road, Thunder Bay, ON
DRAWING TITLE
New Power & Systems Layout

DWG SCALE: As indicated PLOT SCALE: 1:1

DATE ISSUED: Sept 2017
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REV.

